	Architectu	ıral D	esign Spring	g 2025:	Blac	k Box T	he	eater Proj	ect		
TYPE OF WORK: [] NEW CONSTRUCTION [] SINGLE-FAMILY HOUSE [] BUILDINGS CONSISTING OF THREE OR MORE [TOWNHOUSE UNITS [DING REPAIRS ACCESSORY STRUCTURES	N/C - NON-CONFORMING N,	REQUIRED/S — NOT SHOWN ON DIAGRAMSCONFORMS	CODES LEGEND:	NYSBC - 2020 BUIL ANSI A117.1 - 2009 NYSMC - NYS MECH) HAN[NYSPC - NYS PLUMB NYSEC - NYS ENERG NYSFGC - NYS FUEL	Y CODE	2020
1. THE CONSTRUCTION SHALL NOT RESTRICT A FIVE—FOOT CLEAR AND	D UNOBSTRUCTED ACCESS TO ANY V	117 (1 = 1 ()) (32. THE CONTRACTOR SHA			·	NO.	TOPIC	CODE SECTION	PAGE	REQUIRED OR ALLOWED
POWER DISTRIBUTION FACILITY (POWER POLES, PULL—BOXES, TRANSFOR APPURTENANCES, ETC.) OR TO THE LOCATION OF THE HOOK—UP. THE FEET OF ANY POWER LINES —WHETHER OR NOT THE LINES ARE LOCATION CAUSE CONSTRUCTION DELAYS AND/OR ADDITIONAL EXPENSES.	E CONSTRUCTION SHALL NOT BE WIT ATED ON THE PROPERTY. FAILURE TO	THIN TEN O COMPLY	TO COMPLETE THE WORK OR WITHOUT COMPROMISING THE 33. THE CONTRACTOR SHAPPROTECTING ALL WORK DURING	QUALITY OF THE W ALL BE RESPONSIBLE	ORK. E FOR ADEQU	JATELY BRACING AN	11 D	STAIRS UNDER STAIR PROTECTION WIDTH - MINIMUM HEADROOM TREAD DEPTH RISER HEIGHT LANDING SPIRAL	R311.4.9 R3112.2 R311.5.1 R311.5.2 R311.5.3 R311.6.4 R311.5.8.1		GYP. IF ENCLOSED 36 IN. 6FT. 8IN. HEIGHT 9IN. 8-1/4"IN. NP AS ONLY MEAN OF EGRESS FROM A STOR
UNIT OF DWP (213)367-0562. 2. OBTAIN PERMITS FROM PUBLIC WORKS PRIOR TO CONSTRUCTION F A) TEMPORARY PEDESTRIAN PROTECTION AS REQUIRED BY LA B) FOR ANY CONSTRUCTION NEAR ANY STREET OR PUBLIC AF	BC SECTION 3306.		COLLAPSE, DISTORTIONS, AND STANDARDS OF GOOD PRACT 34. THE CONTRACTOR SHA	ICE. ALL CORRECT ANY V	ARIATIONS IN	FLOOR ELEVATIONS	12	HANDRAILS/RAILINGS WHEN REQ'D HEIGHT CONTINUITY GAURDS WHERE REQ'D HEIGHT	R311.4.9 R3115.6.1 R311.5.8.2 R312 R312.1		4 OR MORE RISERS MIN 34 IN./MAX 38 IN. 2X6 ALLOWS 3 STORIES SURFACES RAISED 30" MIN. 36"
3. ALL NEW LIGHTING SHALL BE FROM AN ENERGY HIGH EFFICACY LI SEC. 150(K)) 4. EVERY SPACE INTENDED FOR HUMAN OCCUPANCY SHALL BE PROV	IGHT SOURCE (E.G. FLUORESCENT LA IDED WITH NATURAL LIGHT BY MEANS	AMP). (1-24, IS OF	CREATED BY THE REMOVAL (NEW DOOR OPENINGS. 35. THE CONTRACTOR SHA INTERIOR CMJ PARTITION WAL	ALL NOT CONSTRUCT	, UNLESS OT	HERWISE NOTED,	13 14 15	OPENING LIMITATION SMOKE ALARMS AUTOMATIC SPRINKLER SYSTEMS CO ALARMS REQ'D LOCATIONS FOAM PLASTIC INSULATION WALL AND CRITICAL HOSPITIAN TO ALARMS PRINCE TO ALARMS PLANT CRITICAL TO ALARMS PRINCE ALARMS PLANT CRITICAL TO ALARMS PLANT CRITICAL TO ALARMS PRINCE ALARMS PLANT CRITICAL TO ALARMS PLANT CRITICAL TO ALARMS PRINCE ALARMS PLANT CRITICAL TO ALARMS PLANT CRITICAL TO ALARMS PRINCE ALARMS PLANT CRITICAL TO ALARMS PLANT CRITICAL TO ALARMS PRINCE ALARMS PLANT CRITICAL TO ALARMS PLANT CRITICAL TO ALARMS PRINCE ALARMS PLANT CRITICAL TO ALARMS PLANT CRITICAL TO ALARMS PRINCE ALARMS PLANT CRITICAL TO ALARMS PLANT CRITICAL TO ALARMS PRINCE ALARMS PLANT CRITICAL TO	R312.2 R313.1 R313.3 R313.4 R314		4' SPHERE, 6" TRIANGLE EXCEPT., 4-3/8" STAIR INSIDE, OUTSIDE, & EACH LEVEL, INTERC. & WIRE 3 STORIES IF CO SOURCE EXISTS STORY WITH SLEEPING, WITH CO SOURCE
EXTERIOR GLAZED OPENINGS IN ACCORDANCE WITH SECTION R303.1 (THAT IS ADEQUATE TO PROVIDE AN AVERAGE ILLUMINATION OF 6 FOO A HEIGHT OF 30 INCHES ABOVE THE FLOOR LEVEL. (R303.1) 5. A COPY OF THE EVALUATION REPORT AND/OR CONDITIONS OF LIST	OT—CANDLES OVER THE AREA OF THE	E ROOM AT	ARE IN PLACE. 36. THE CONTRACTOR SHA	ALL INSTALL SUSPEN	DED CEILINGS	S, TO MEET THE	16	INTERIOR COVERINGS PLASTER GYPSUM EXTERIOR SIDING COVERINGS DWELLING SEPARATION TWO-FAMILY - REQUIRED	R315.1 R702 TABLES R702.1 (1) TO (3) R702.3.5 R703 TABLES R703.4 & R703.5.2		NOT GREATER THAN 200 BASED ON MATERIAL USED BASED ON MATERIAL USED 1 HR. MIN
SITE. 6. THE SPRINKLER SYSTEM SHALL BE APPROVED BY PLUMBING DIVISIONAL ARE REQUIRED TO BE CONNECTED TO A SANITARY SEWER OR TO AN TO A MAINTENANCE OF VEHICLE LIFT SYSTEM (2-LEVELS OR MORE) A	APPROVED SEWAGE DISPOSAL SYSTE	EM (R306.3)	37. THE CONTRACTOR SHA CEILINGS, ETC DAMAGED OF FINISH TO MATCH ADJOINING 38. AT TOILET AREAS AND	R EXPOSED DUE TO SURFACES.	WORK OR R	EMÓVALS AND	17	SPRINKLER EXCEPTION TOWNHOUSES, SEPARATE BIDGS. EXTERIOR WALL EXCEPTION: COMMON WALL PARAPET WALLS STRUCTURAL PROTECTION OF THE STRUCTURE DECAY TERMITES	R317.2 R317.2.2 & R317.2.3 R321.2.4		1/2HR MIN EACH 1 HR MIN 2 HR MIN 1 HR MIN INDEPENDENT
APPROVED AND RECORDED PRIOR TO ISSUING A BUILDING PERMIT. 8. ALL FOOTINGS SHALL BEAR ON UNDISTURBED VIRGIN SOIL HAVING 9. ALL FOUNDATION WALLS AND VERTICAL CONCRETE EXPOSED TO WE SHALL BE MIN 3000 PSI PLAIN CONCRETE, AIR ENTRAINED IN FREEZE	A MIN. BEARING CAPACITY OF 3000 EATHER AND FOOTINGS AND BASEMEN	D PSI. ENT SLABS	DRAIN "BELOW FINISH FLOO CONCRETE TO DRAIN. ALL VE OF 2—HOURS UNLESS REQUI	R AND PROVIDE A TERTICAL SHAFTS SHA	WO (2) FEET LL HAVE A M	SWALE IN MINIMUM FIRE RATIN	9	TERMITES EXTERIOR WINDOWS AND GLASS DOORS PERFORMANCE TESTING/LABELING WIND-BORNE DEBRIS ANCHORAGE MILLIONS	R320 R613 R613.2 R613.3 R613.4, R613.6 R613.5		SAME REQ'D, (613.4 ALL GLAZING) (613.6 MULLIONED GLAZING)
10. ALL PORCHES, CARPORTS SLABS, STEPS EXPOSED TO THE WEATH 3,500 PSI AIR ENTRAINED CONCRETE. 11. ALL FOOTINGS SHALL BE POURED AT A MIN DEPTH OF 3' BELOW 12. DAMP PROOF ALL CONCRETE WALLS ENCLOSING HABITABLE OR U	HÉR. AND GARAGE FLOOR SLABS SHA V GRADE REGARDLESS OF SOIL CONI	DITIONS.	ADJACENCIES. 39. THE CONTRACTOR SHAFIXTURES PRIOR TO THE CONTRACTOR CHARLES	NSTRUCTION OF PAR	TITIONS BEHI	ND SUCH FIXTURES		FIREPLACES AND STOVES MASONRY FIREPLACES FACTORY BUILT FIREPLACES EXTERIOR AIR SUPPLY CHIMNEYS AND GAS VENTS MASONRY CHIMNEYS	CHAPT.10 R1003 R1004 R 1005 CHAPTS.10,18,24 R1001		
13. ON NEW CONSTRUCTION OVER EXISTING, VERIFY EXISTING POURED 14. ALL STEPPED FOOTINGS SHALL HAVE FLAT TOPS AND BOTTOMS LISHALL BE STEPPED AT A 12 SLOPE MAX. MAINTAINING THE THICKNES 15. THE CONTRACTOR SHALL COORDINATE AND PLACE ALL SLEEVES FOR THE CONTRACTOR SHALL COORDINATE AND PLACE ALL SLEEVES FOR THE CONTRACTOR SHALL COORDINATE AND PLACE ALL SLEEVES FOR THE CONTRACTOR SHALL COORDINATE AND PLACE ALL SLEEVES FOR THE CONTRACTOR SHALL COORDINATE AND PLACE ALL SLEEVES FOR THE CONTRACTOR SHALL COORDINATE AND PLACE ALL SLEEVES FOR THE CONTRACTOR SHALL COORDINATE AND PLACE ALL SLEEVES FOR THE CONTRACTOR SHALL COORDINATE AND PLACE ALL SLEEVES FOR THE CONTRACTOR SHALL COORDINATE AND PLACE ALL SLEEVES FOR THE CONTRACTOR SHALL COORDINATE AND PLACE ALL SLEEVES FOR THE CONTRACTOR SHALL COORDINATE AND PLACE ALL SLEEVES FOR THE COORDINATE AND PLACE A	D CONCRETE SPREAD FOOTINGS. LEVEL AND TRUE TO INSURE MAX BE SS, AS NOTED ON THE DRAWINGS AT	EARING AND T ALL POINTS.	40. THE CONTRACTOR SHALL AND CLOSETS. 41. UNLESS OTHERWISE NOT A RUNNING BOND.					MASONRY CHIMNEYS FACTORY-BUILT CHIMNEYS DRAFT FIRE BLOCKING MULTIPLE-APPLIANCE VENTING PLUMBING FIXTURES REQUIRED FIXTURE SPACING WASTE TYPE/APPROVAL WATER-SOURCE/APPROVAL ANTI-ACALD DEVICES	R1002 M 1801.2 M 1801.9 & R802.8 M1801.14 CHAPT. 33-42 R308 R307.1, FIG. 307.2 R306.3 & P2602 R306.4 & P2602		
OTHER TRADE PERFORMING WORK THAT REQUIRES PASSING THROUGH 16. ALL SHEATHING AND SUBFLOORING SHALL BE SPECIES GROUP INDICATED. 17. CROSS BRIDGING OR SOLID BLOCKING SHALL BE INSTALLED AT	ANY FOUNDATION WALLS. ONE. EXTERIOR GRADE: THICKNESS	AS	42. FIRESTOPPING SHALL BE CONSTRUCTION AS PER SPECAPPROPRIATE FOR, AND BE	CIFICATIONS. FIRESTO PART OF A LISTED ,	PPING MATER AND LABELED	RIALS ARE TO BE ASSEMBLY IN	21	WATER-SOURCE/APPROVAL ANTI-ACALD DEVICES ELECTRICAL REQUIREMENTS RECEPTACLE PLACEMENT GFCI AND ARC FAULT SWITCH LOCATIONS ENERGY COMPLIANCE	P2602.2 CHAPT. 33-42 E3801.21 E3802 E3805		12FT.MAX GFCI 9 LOCATION ARE FAULT FOR BEDROOMS 1 PR. HABITBLE. RM & BTHRM
BLOCKING/ FIRESTOPPING AT BEARING PARTITIONS. 18. ALL HORIZONTAL FRAMING BEARING ON BEAMS, GIRDERS OR PLAPPED 4 MIN. (SEE BLOCKING NOTE).		⊢	ACCORDANCE WITH THE BUIL NO. TOPIC	CODE SECTION				CLIMATE ZONE HEATING DEGREE DAYS BUILDING ENVELOPE FENESTRATION U-FACTOR SKYLIGHT U-FACTOR GLAZING SHGC	CHAPT. 11 TABLE N1.101.2 TABLE N1.102.1		
19. ALL FLUSH FRAMING SHALL BÉ CONNECTED WITH MANUFACTUR ORDER TO SUPPORT THE REACTIVE LOAD OF THE MEMBER SUPPORTE	ED.		NYRC LIMITATION STATE AGENCY REGULATION COMMUNITY RESIDENCE HOSPICE CONVERSION TO BED&BREAKFAST	R101.2 R101.2.1 AJ701		3 STORY, SEPARATE AGREES		CEILING H-VALUE WOOD WALL R-VALUE FLOOR R-VALUE BASEMENT WALL R-VALUE SLAB R-VALUE, DEPTH CRAWL SPACE	FOONVOLLED		
20. INSTALL FIRE STOPPING AT ALL REQUIRED LOCATIONS TO COMP 21. PROVIDE FIRE RATED ASSEMBLIES AS CALLED FOR ON DRAWING 22. ALL STEEL SHALL BE TYPE A36, FY 36 KSI.	GS.		BUILDING HEIGHT NUMBER OF STORIES WOOD STEEL IFC FOUNDATION	TAB R602.3(5) R605.1 R404.4.1		SPECIFIC LIMT. BASED ON MATERIALS 2X6 ALLOWS 3 STORIES 2 STORIES MAX 2 STORIES MAX		CRAWL SPACE ENERGY CODE ALTERNATIVE RES CHECK COMPLIANCE	ECCNY CHAP. 4		
23. LICENSED CONTRACTORS IN ACCORDANCE WITH APPLICABLE CO PERFORM ALL PLUMBING, HVAC, AND ELECTRICAL WORK. 24. ALL STORM WATER AND SEWAGE DISPOSAL SYSTEMS SHALL BE			B DESIGN & LOAD LIMITATION WIND SEISMIC SNOW LOAD	TAB R301.2(1) R301.2.1 R301.2.2 R301.2.3 TAB R301.5		CHECKLIST PG. 1 110 MPH CATEGORY D1 OVER 70 PSF GROUND SNOW					
CODES AND HEALTH DEPT. REGULATIONS. 25. ALL NEW UTILITIES INDICATED SHALL BE DESIGNED. INSTALLED, 26. ALL NEW CONSTRUCTION SHALL MEET THE REQUIREMENTS OF 27. ALL BEAMS IN CEILING CONCEALED UNLESS OTHERWISE NOTED	AND TERMINATED BY LOCAL UTILITY LOCAL AUTHORITIES.		LIVE LOAD LOCATION ON LOT LIGHT & VENTILATION HABITABLE LIGHT HABITABLE VENTILATION STAIRWAY ILLUMINATION	R302 R303 R303.1 R303.1 R303.4		> 3' FROM LOT LINE = (1HR.) 8% OF FLOOR AREA 4% OF FLOOR AREA ARTIFICIAL LIGHT REQ'D	_ 	LAGE OF FARMINGDALE BUIL IIS NOTE IS PLACED ON THE RMINGDALE BUILDING DEPAR	SE DRAWINGS AS REQUIREI	D BY THI	E VILLAGE OF
28. ANY DISCREPANCIES SHALL BE REPORTED TO THE ARCHITECT 29. THE CONTRACTOR SHALL FIELD VERIFY ALL DIMENSIONS AND C 30. THE CONTRACTOR SHALL, UNLESS OTHERWISE PROVIDED IN THE THE REQUIRED CONSTRUCTION PERMIT(S). FEES. LICENSES AND INSPE	CONDITIONS OF THE SITE AND/OR BUILDED FOR THE CONTRACT DOCUMENTS, SECURE A	AND PAY FOR	ROOM AREA HABITABLE ROOM OTHER ROOMS CEILING HEIGHT HABITABLE OTHER ROOMS	R304.1 R304.2, R304. R305.1	}	MIN. 120 SF (1 ROOM) 70 SF OTHER ROOMS, 7' MIN DIMENSIONS 7'-8" IN.MIN 7' MIN.		LAGE OF FARMINGDALE BUILD CUMENT FOR THE MINIMUM OWN OF ISLIP AS SPECIFIED	ACCEPTABLE PLAN SUBMITT	TAL REQU	JIREMENTS OF THE

GLAZING SAFETY GLAZING LOCATIONS SKYLIGHTS/SLOPED GLAZING

GARAGE - ATTACHED

FLOOD HAZARDS

CALL THE PLANS EXAMINERS OFFICE 599

ICE SHIELD UNDERLAYMENT

SEE BLW. REQ'D

THE REQUIRED CONSTRUCTION PERMIT(S), FEES, LICENSES AND INSPECTIONS NECESSARY FOR THE PROPER

CODE COMPLIANCE DIVISION OF THE AUTHORITY.

TIMELY COMPLETION OF THE WORK/PROJECT.

130 VULT

GROUND SNOW LOAD

EXECUTION OF TIC WORK. APPLICATION FOR CONSTRUCTION PERMITS SHALL BE PROCESSED THRU THE BUILDING

31. COORDINATION OF ALL WORK UNDER THIS CONTRACT SHALL BE MAINTAINED TO ENSURE THE QUALITY AND

CLIMATIC AND GEOGRAPHIC DESIGN CRITERIA

BOF 3FT BFG

WEATHERING

SEVERE

THE ENCLOSED DUCUMENT FOR THE MINIMUM ACCEPTABLE PLAN SUBMITTAL REQUIREMENTS OF THE TOWN OF ISLIP AS SPECIFIED IN THE BUILDING AND/OR RESIDENTIAL CODE OF THE STATE OF NEW YORK. THIS REVIEW DOES NOT GUARANTEE COMPLIANCE WITH THAT CODE. THE SEAL AND SIGNATURE OF THE DESIGN PROFESSIONAL HAS BEEN INTERPRETED AS AN ATTESTATION THAT, TO THE BEST OF THE LICENSEE'S BELIEF AND INFORMATION, THE WORK IN THE DOCUMENT IS:

ACCURATE

3/4 HR. SELF-CLOSING DOOR

ONE LAYER 5'6" TYPE X

24 IN (NET CLEAR)

20 IN (NET CLEAR)

MIN. 1 PER DWELLING UNIT

3FT/6FT-8IN SIDE HINGED

3/4 HR.WALL, ONE LAYER 5'8" TYPE X

R308 R308.4 R308.6

R309 R309.1 R309.2.1 EXCEPT. R309.2.2

- CONFORMS WITH GOVERNING CODES APPLICABLE AT THE TIME OF SUBMISSION
- CONFORMS WITH REASONABLE STANDARDS OF PRACTICE AND WITH VIEW TO THE SAFEGUARDING OF LIFE, HEALTH, PROPERTY AND PUBLIC WELFARE
- IS THE RESPONSIBILITY OF THE LICENSEE

Project Section	49	
Block	001	
Lot # :	17	

General Notes

Camps Architects

PROJECT ADDRESS:

FARMINGDALE NY, 11735

141 DIVISION ST.

DRAWN BY: S.C DATE: 19MAY2025

NYSFC - NYS FIRE CODE 2020

DRAWING LEGEND

A2 - FOUNDATION PLAN

A3 - FIRST & SECOND

CS - COVER SHEET

A1 – SITE PLAN

A4 - ROOF PLAN

A6 – ELEVATIONS

A5 - R.C PLAN

A7 - SECTIONS


R101 – STK SET

R102 - STK SET

A8 - DETAILS


FLOOR PLAN



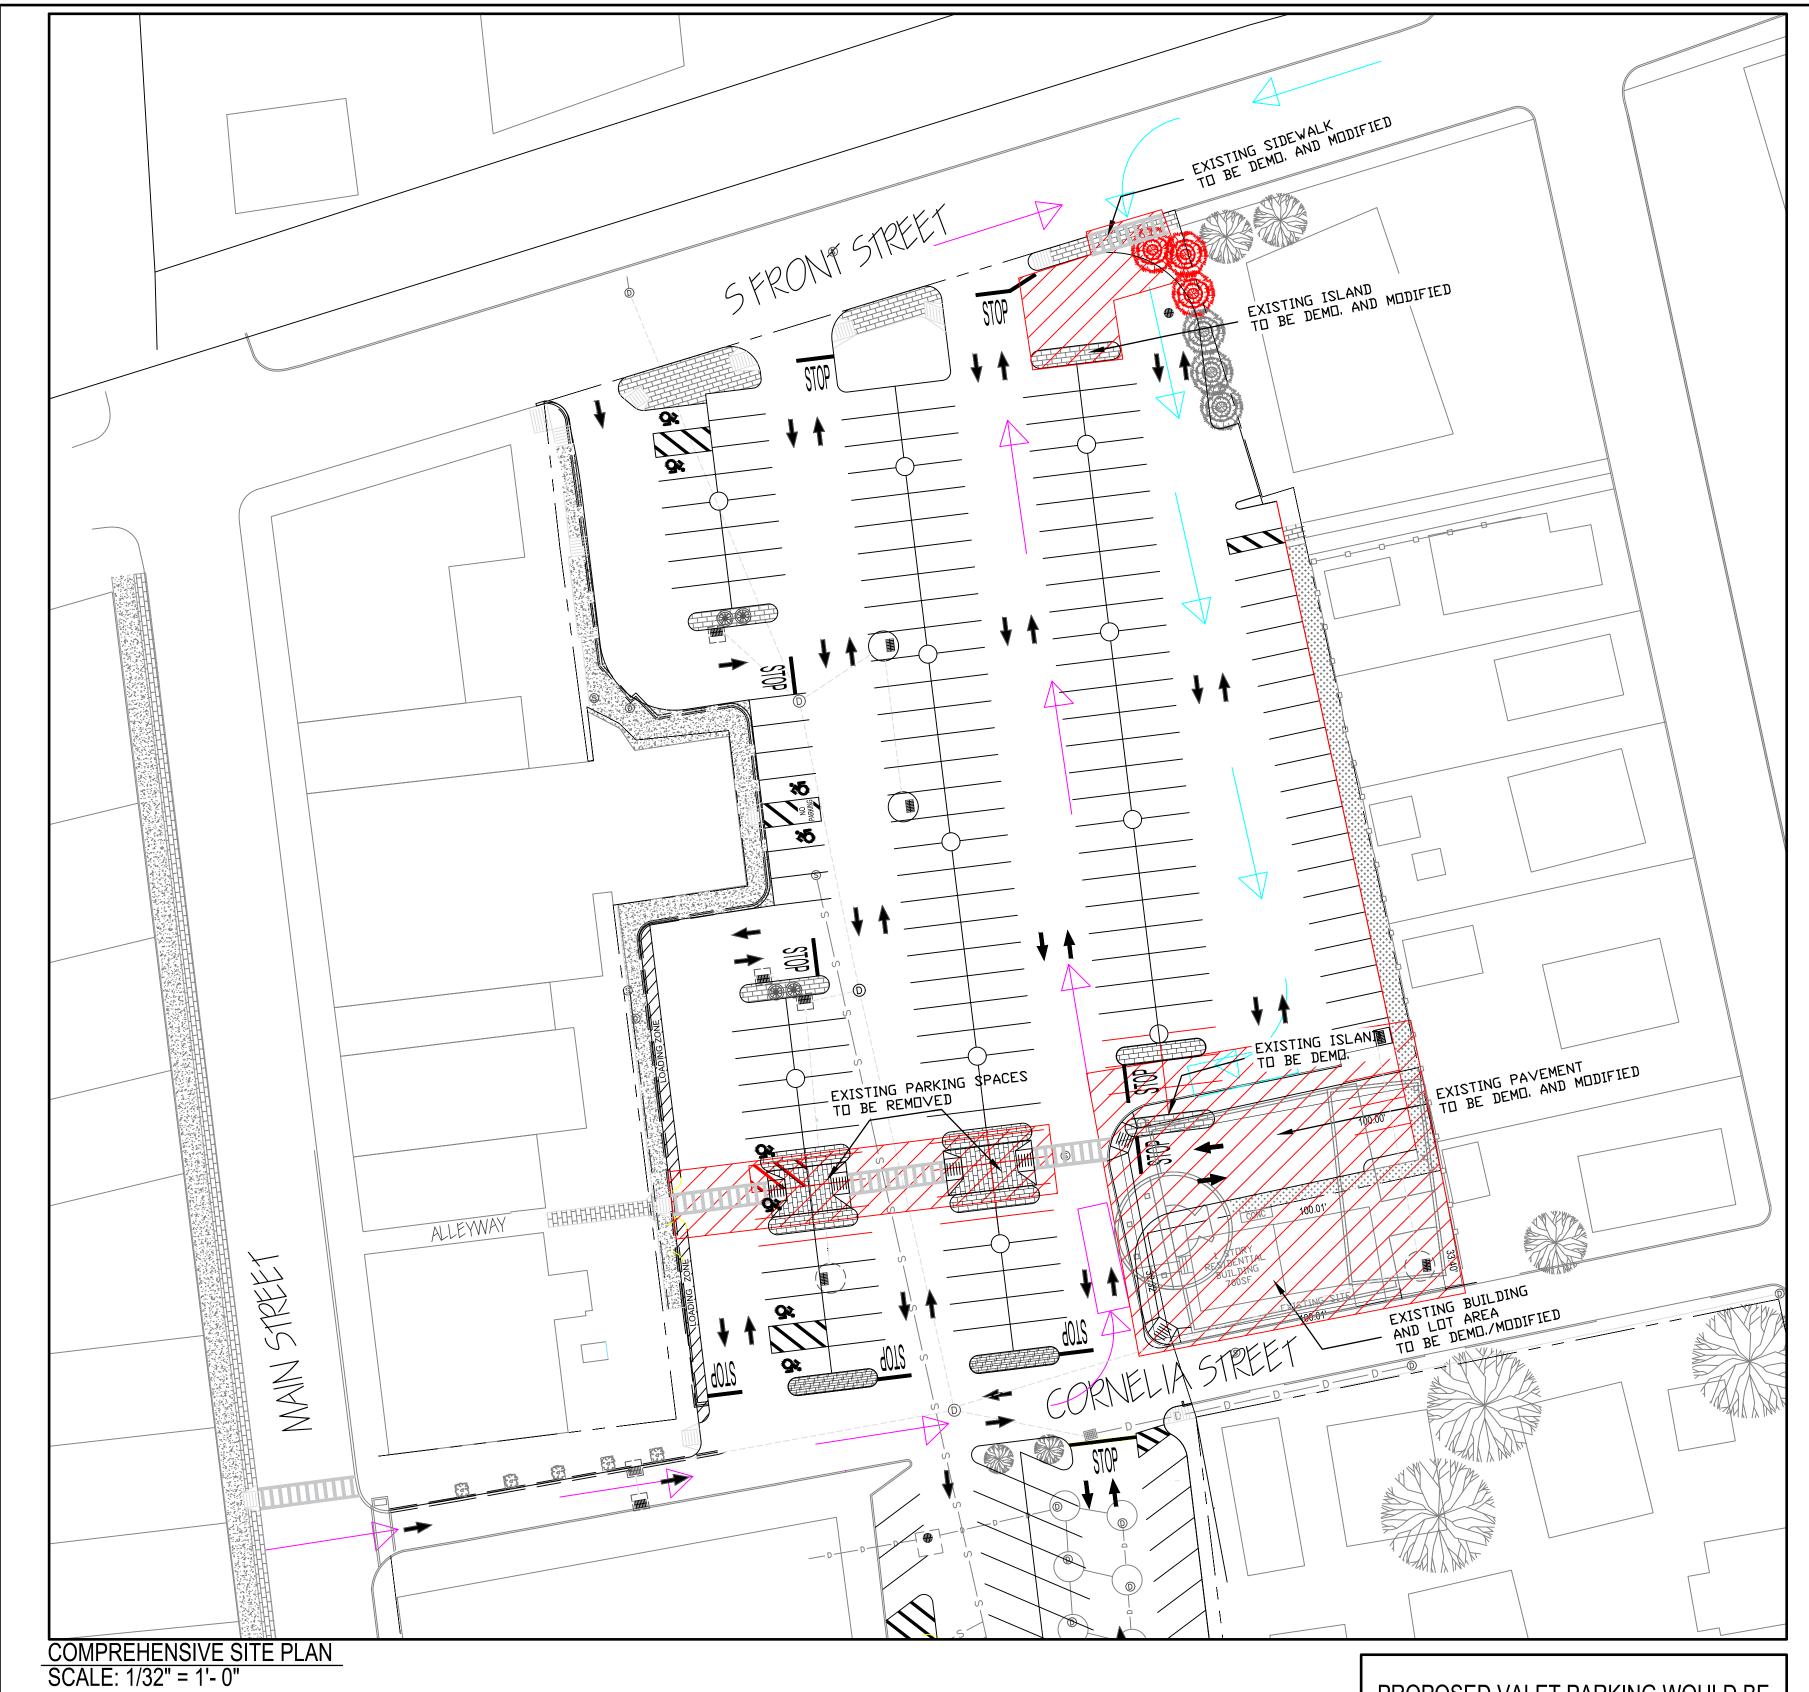


PROPOSED VALET PARKING WOULD BE CONSIDERED AT THE LIRR TRAIN THE LIRR, THEN PARKING WOULD BE AT THE AQUATIC CENTER.



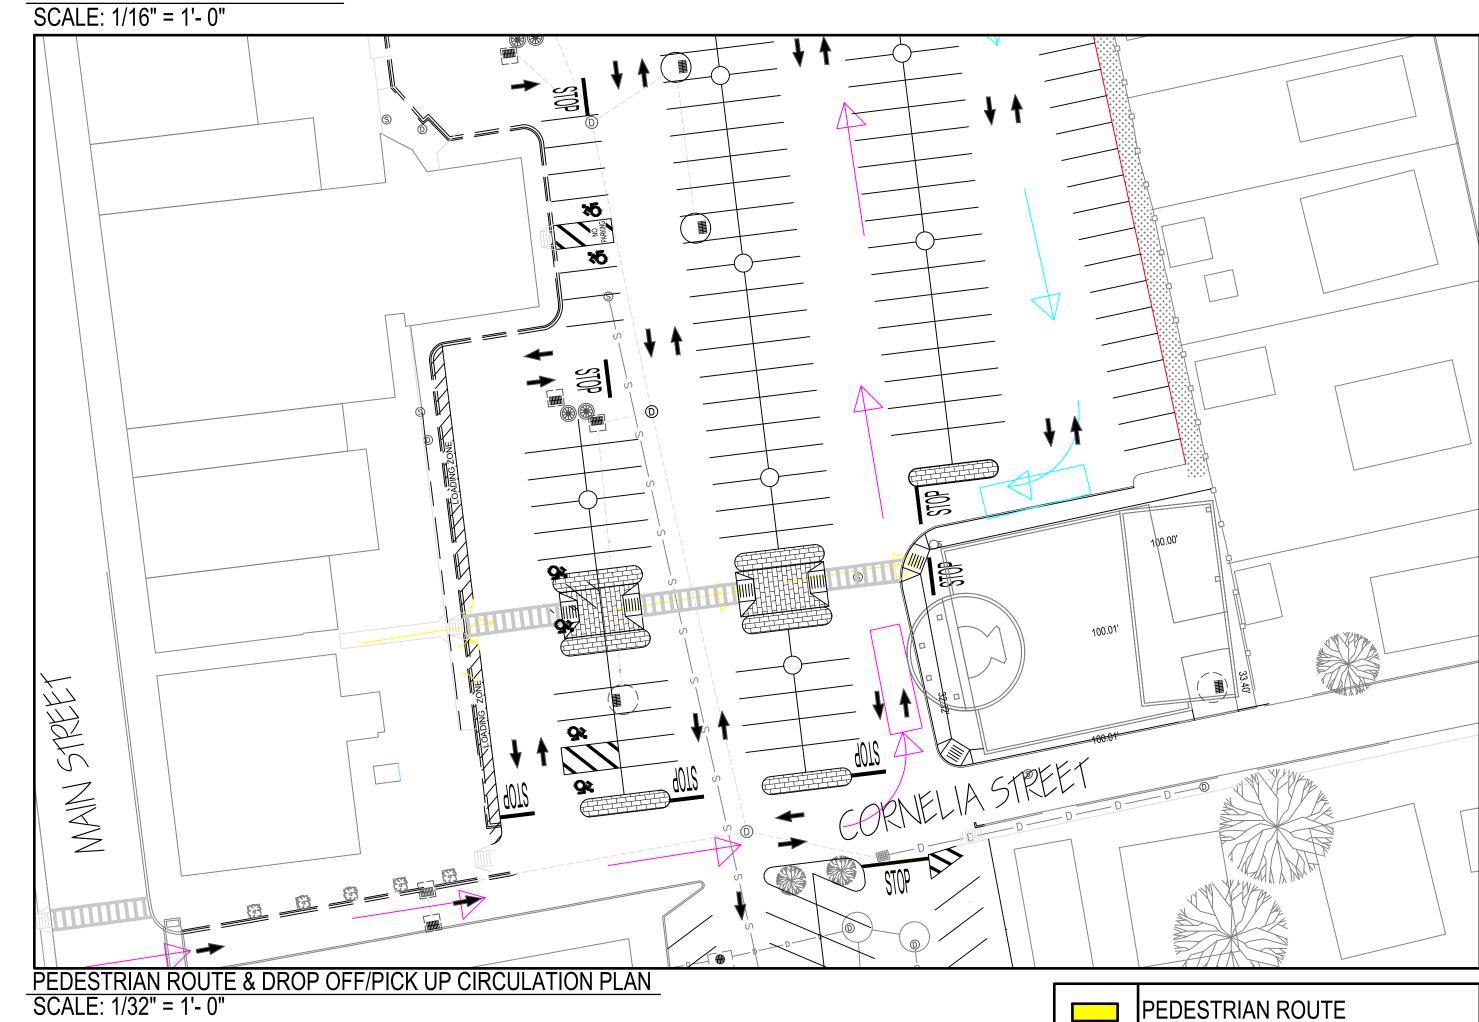

STATION AND IF THERE'S NO SPACE AT

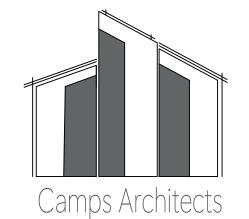

DESIGN 4 PROFESSOR ANDERSON FARMINGDALE STATE COLLEGE 2350 BROADHOLLOW ROAD FARMINGDALE NY 11735

PRELIMINARY SITE PLAN

PROJECT ADDRESS: 141 DIVISION ST. FARMINGDALE NY, 11735

TAX MAP #: 49 - 001 - 17 DRAWN BY: STEPHANIE CAMPOS DATE: 14APRIL2025 SCALE: 1/32" = 1'-0"

REVISIONS:

SHEET TITLE

DROP OFF CIRCULATION


PICK UP CIRCULATION

DEMOLITION


R-102

PAGE: 9 OF 15

Loading Dock underneath Main Entrance EXISTING BUILDING BE DEMO, /MODIFIED SCALE: 3/32" = 1'- 0" SCALE: NTS

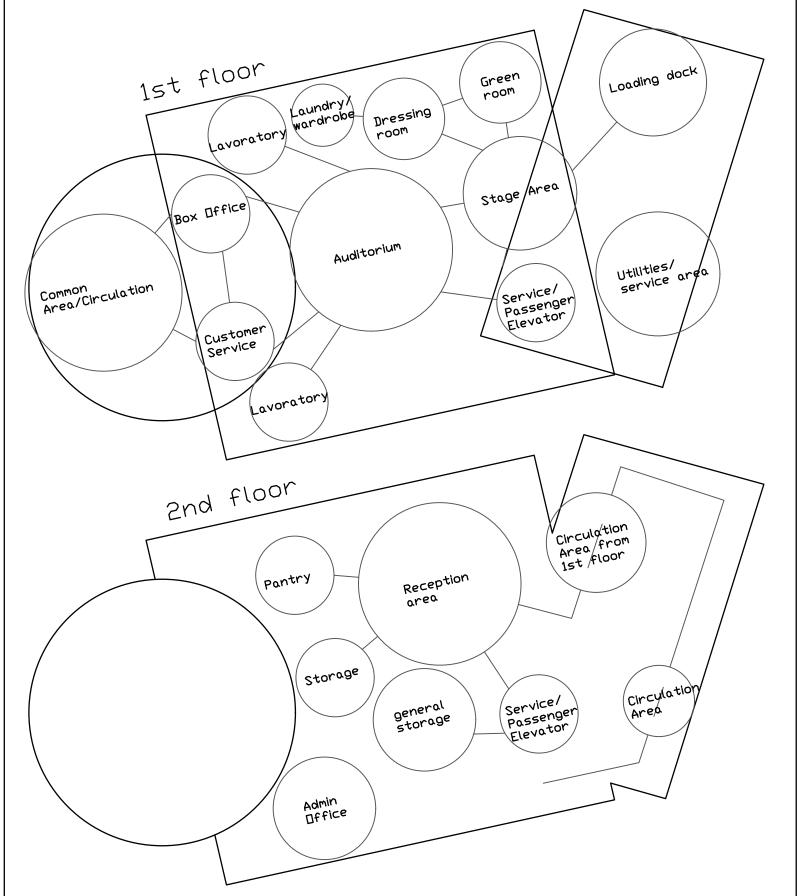



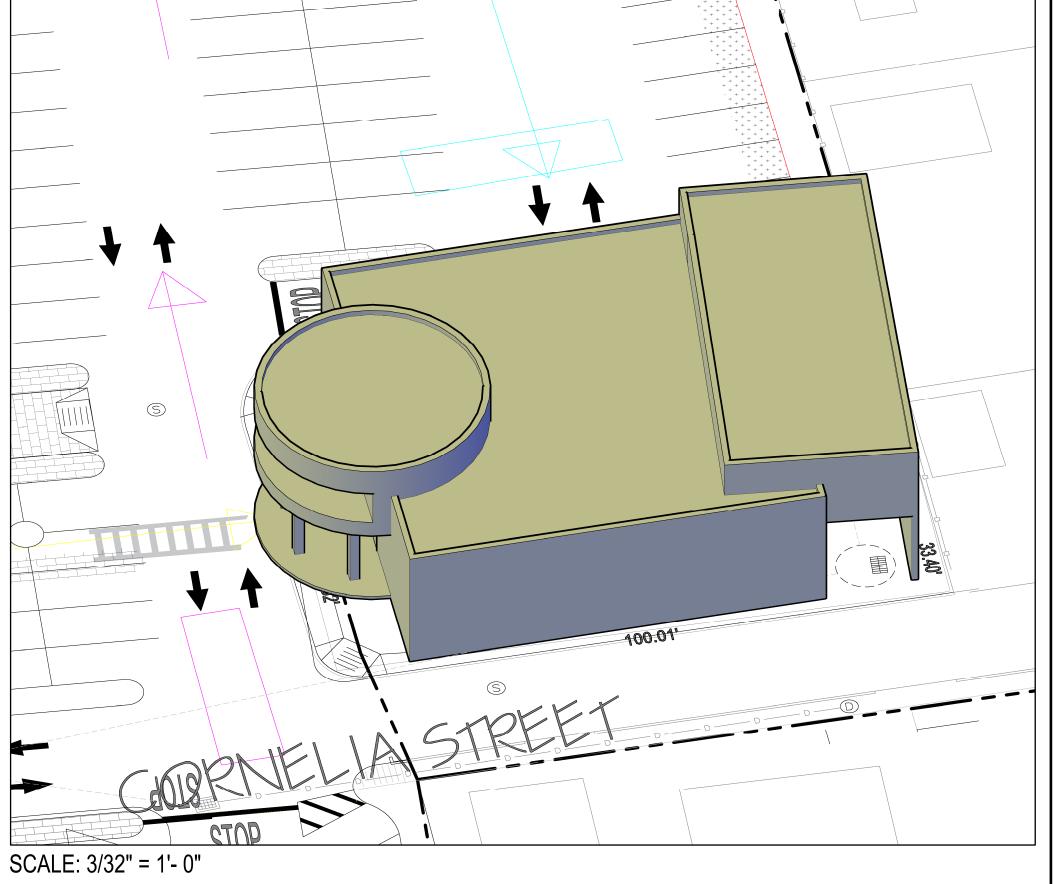

DESIGN 4 PROFESSOR ANDERSON FARMINGDALE STATE COLLEGE 2350 BROADHOLLOW ROAD

FARMINGDALE NY 11735

PROJECT NARRATIVE

NARRATIVE

Introduction: The Village of Farmingdale plans to develop a Performing Arts Center on a site adjacent to the Main Street district to provide a flexible community space to host community-based drama, music and cultural performances. The village has identified the site at 141 Division Street, which is adjacent to the east parking area serving the Main St. district between Conklin St. and Front St. The project program and design response will be developed using a black box theater concept that provides a flexible lobby/arrival area, flexible staging and seating for 130-180 people with performance support spaces and building support spaces.

Conceptual Idea: The proposed Performing Art Center (PAC) in Downtown Farmingdale will feature:

- A striking architectural design that harmoniously blends a circular main entrance with uniquely shaped rectangular elements.
- The circular entrance symbolizes inclusivity and community, inviting residents and visitors into a vibrant cultural hub.
- A central rectangular structure as the main performance space, providing versatile functionality for various events.
- An angled rectangular extension adds dynamic visuals interest and further enhances the building's adaptability, allowing for additional programing and community engagement.

This innovative design not only distinguishes the PAC as a landmark but also fosters social interaction and accessibility. The circular entrance facilitates smooth pedestrian flow, while the entire structure prioritize universal access, ensuring everyone can enjoy the arts. Sustainability is key, with large glass panels maximizing natural light and promoting energy efficiency. By attracting visitors and supporting local artists, the PAC will act as a catalyst for economic revitalization in Downtown Farmingdale, enriching the community and enhancing its cultural landmark.

SWOT Analysis:

- **Strengths**: A uniquely shaped entrance that visually attracts people coming from main street. Energy efficiency, contributing to energy savings reducing operational costs.
- Weaknesses: The parking lot layout may not be favorable considering the size of the Performing Art Center. The design of the parking lot needs to be adjusted, if not the circulation from main street to the PAC is unfavorable. Higher maintenance needs, may require more frequent maintenance and cleaning, increasing operational costs over time. Potential service access conflicts.
- **Opportunities**: Visual landmark for the village, can facilitate better pedestrian flow. Gathering space encouraging social interaction before and after performances. Maximized use of natural lighting in the building contributing to energy efficiency. Working with local artists featuring their artistic elements to enhance the aesthetic appeal.
- Threats: Higher quality materials will affect construction costs. Engineering complexity, may create confusion to visitors unfamiliar with the space leading to disorientation during events. Cultural resistance/mixed community reaction: may be perceived too modern or out of character with the surrounding architecture.

PROJECT ADDRESS: 141 DIVISION ST. FARMINGDALE NY, 11735

DATE: 14APRIL2025 SCALE: AS NOTED **REVISIONS:**

R-101


PAGE: 10 OF 15


SHEET TITLE



SCALE: 1/64" = 1'- 0"

TAX MAP #: 49 - 001 - 17 DRAWN BY: STEPHANIE CAMPOS

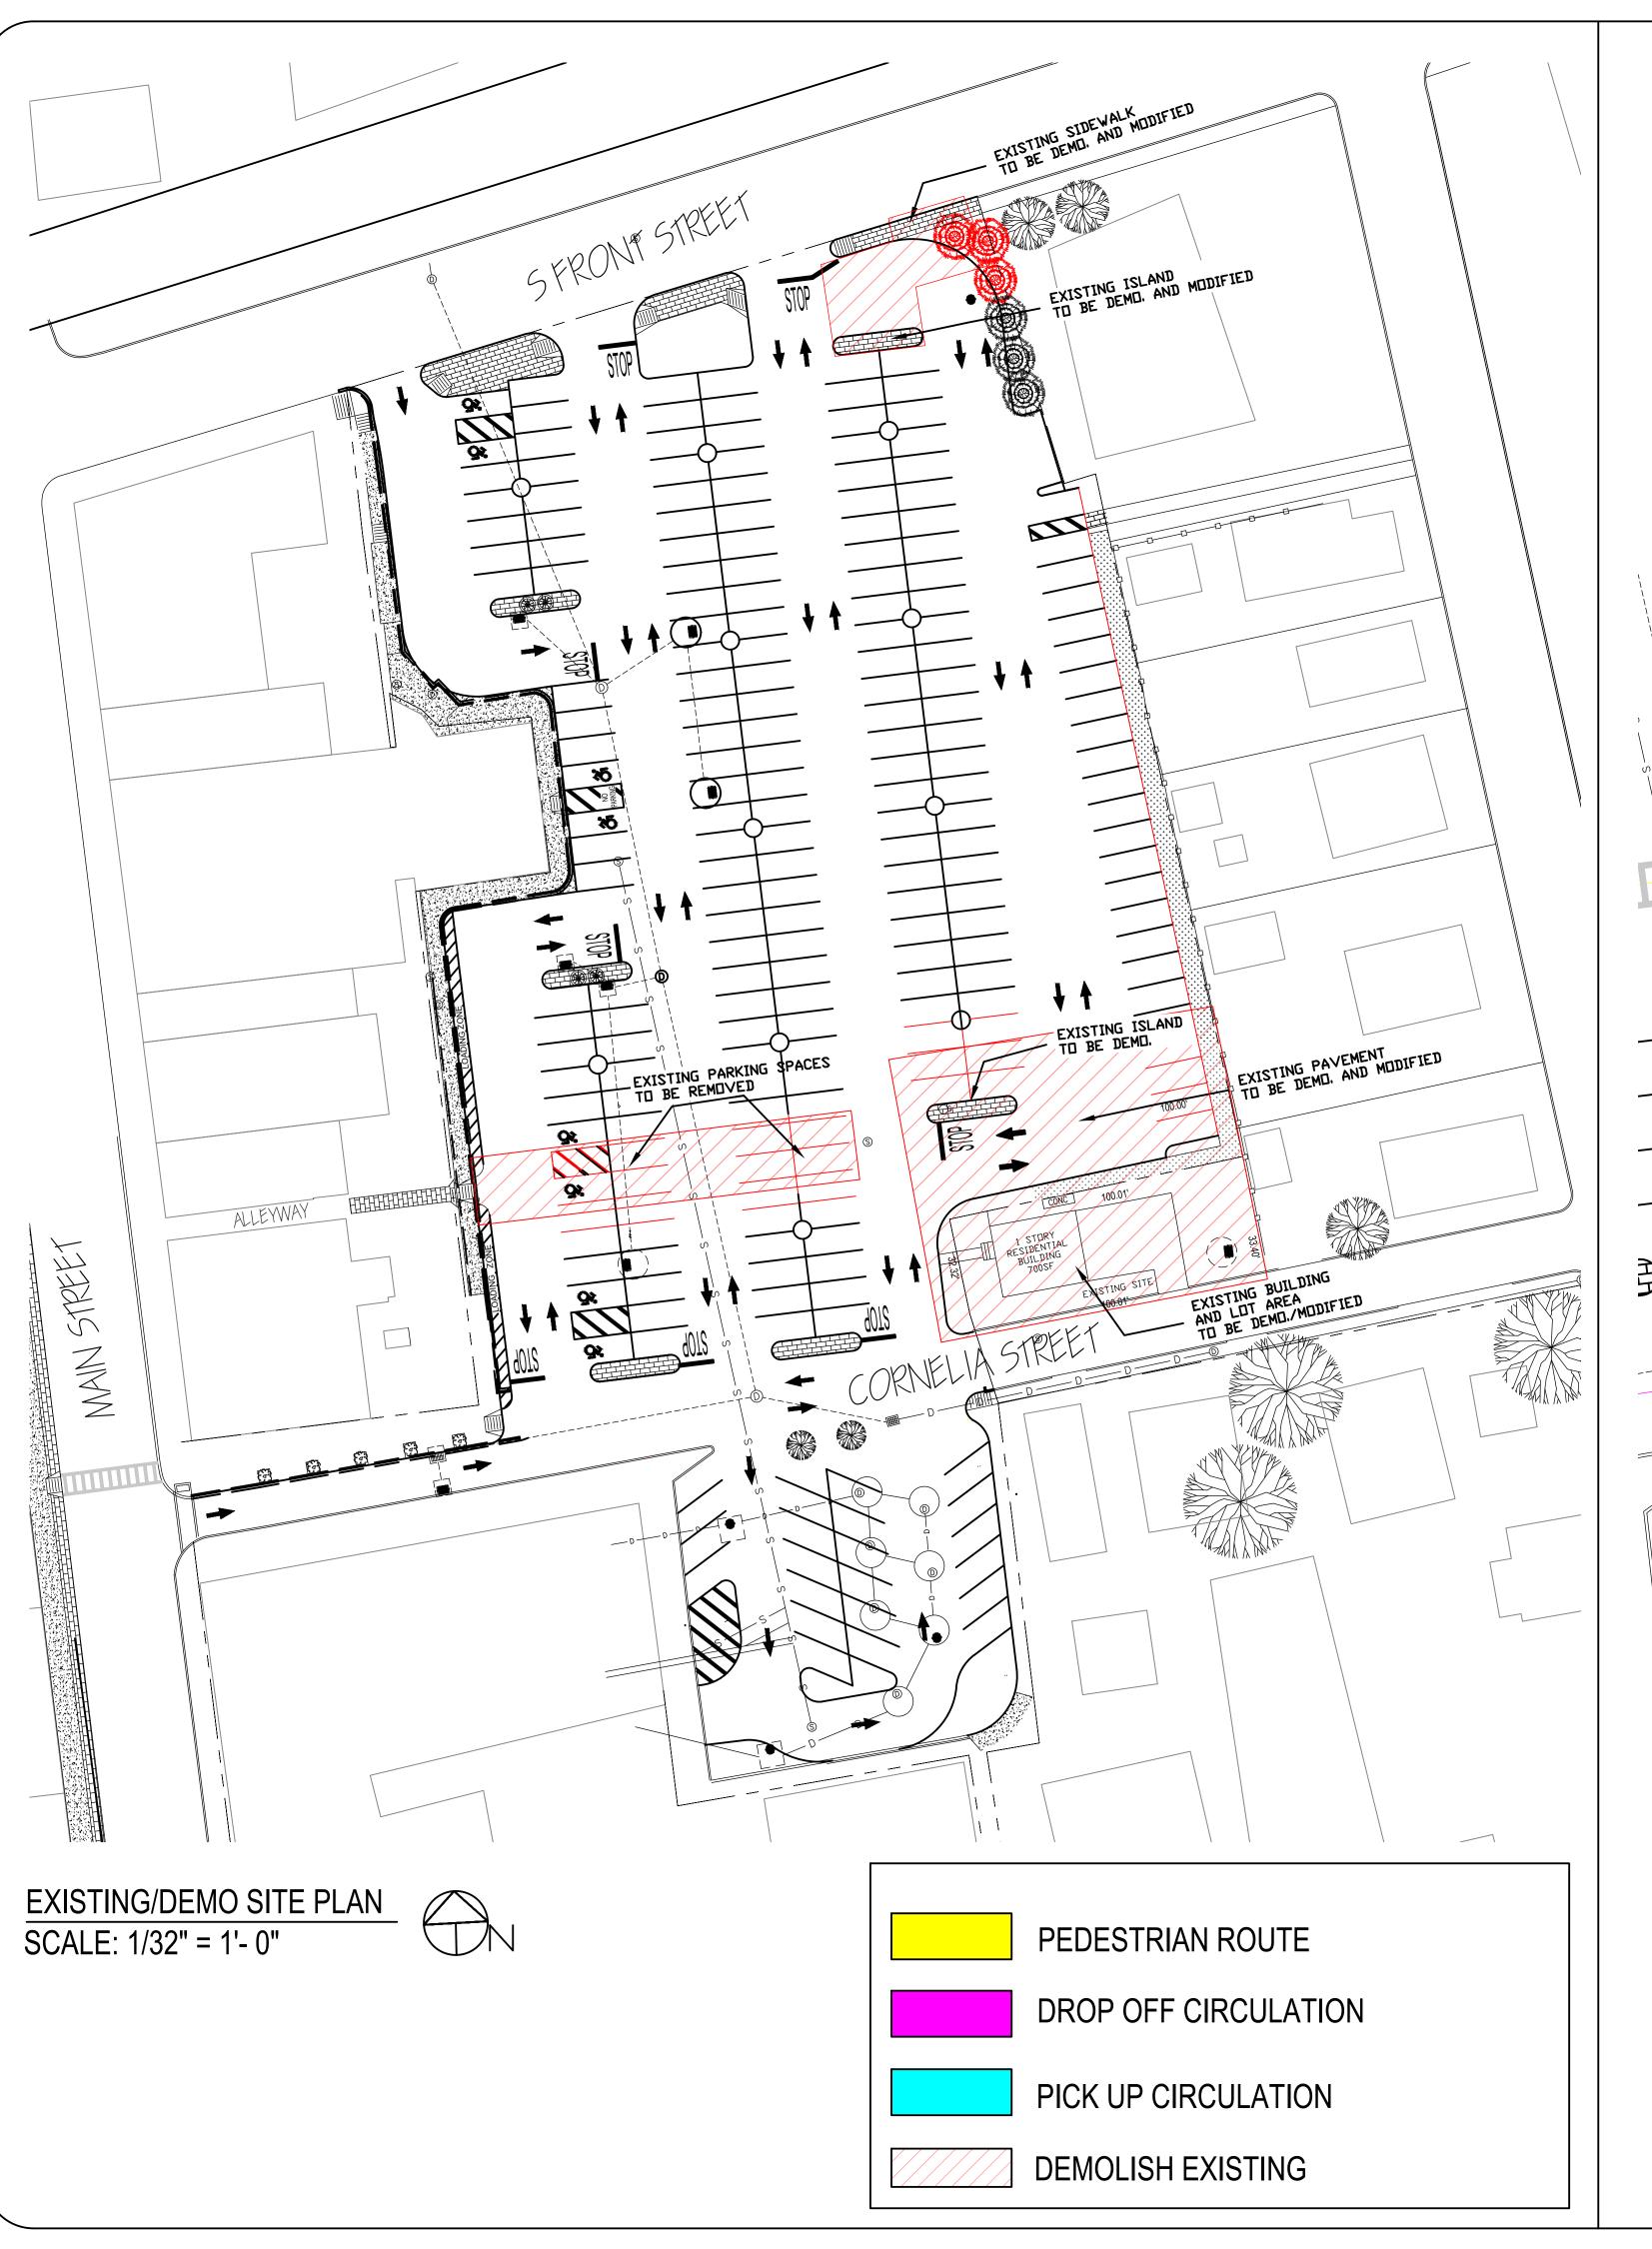

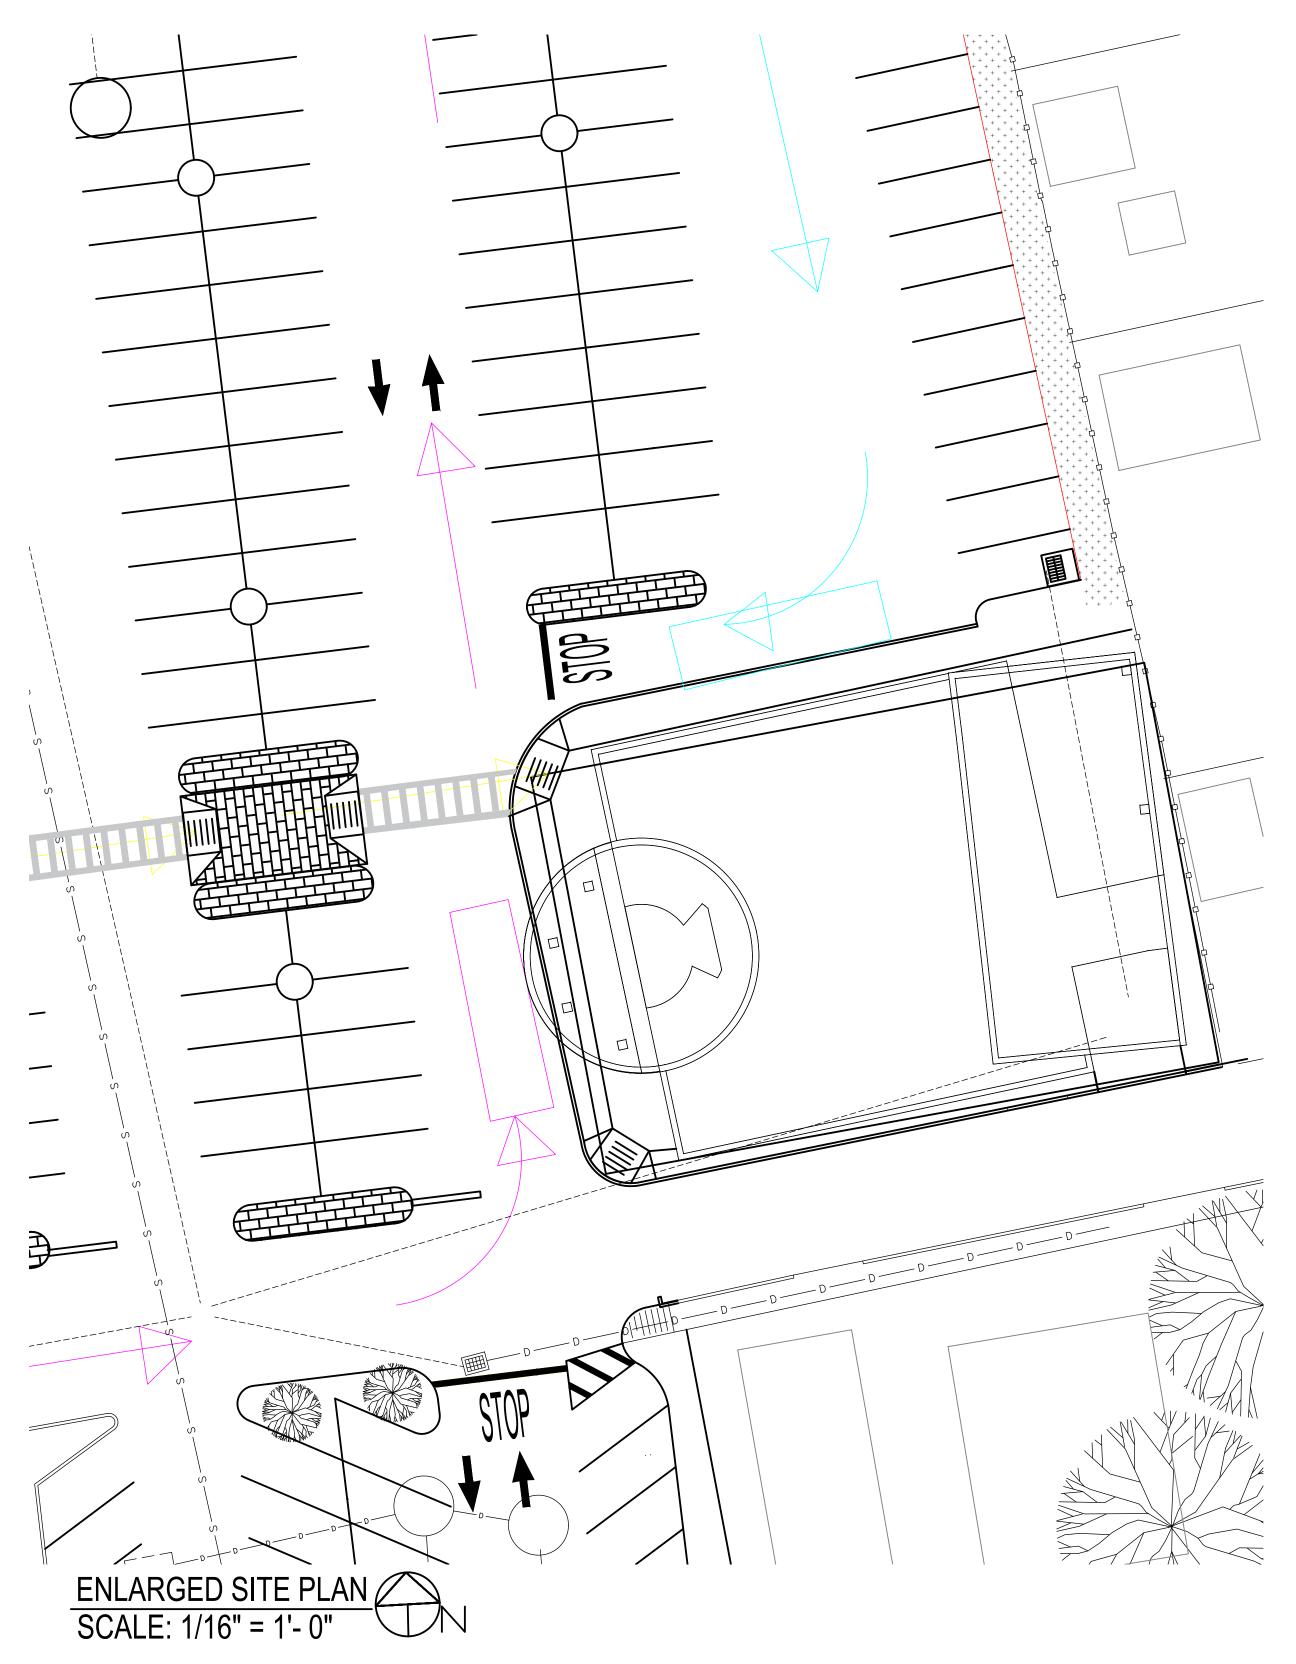

SITE DATA

Downtown Mixed-Use (D-MU) Zoning District


SECTION: 49 BLOCK: 001 LOT #: 17

CURRENT LOT SIZE = 3200 SF

GFA = 1466 SF

General Notes

DESIGN 4
PROFESSOR ANDERSON
FARMINGDALE STATE
COLLEGE
2350 BROADHOLLOW
ROAD
FARMINGDALE NY 11735

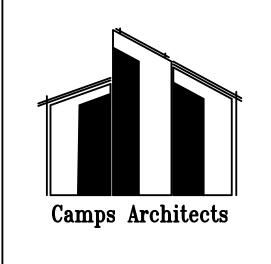


PROJECT ADDRESS: 141 DIVISION ST. FARMINGDALE NY, 11735


> DRAWN BY: S.C DATE: 19MAY2025 SCALE: AS NOTED

SITE PLAN

Desirat Cartina		
Project Section	49	
Block	001	
Lot #:	17	

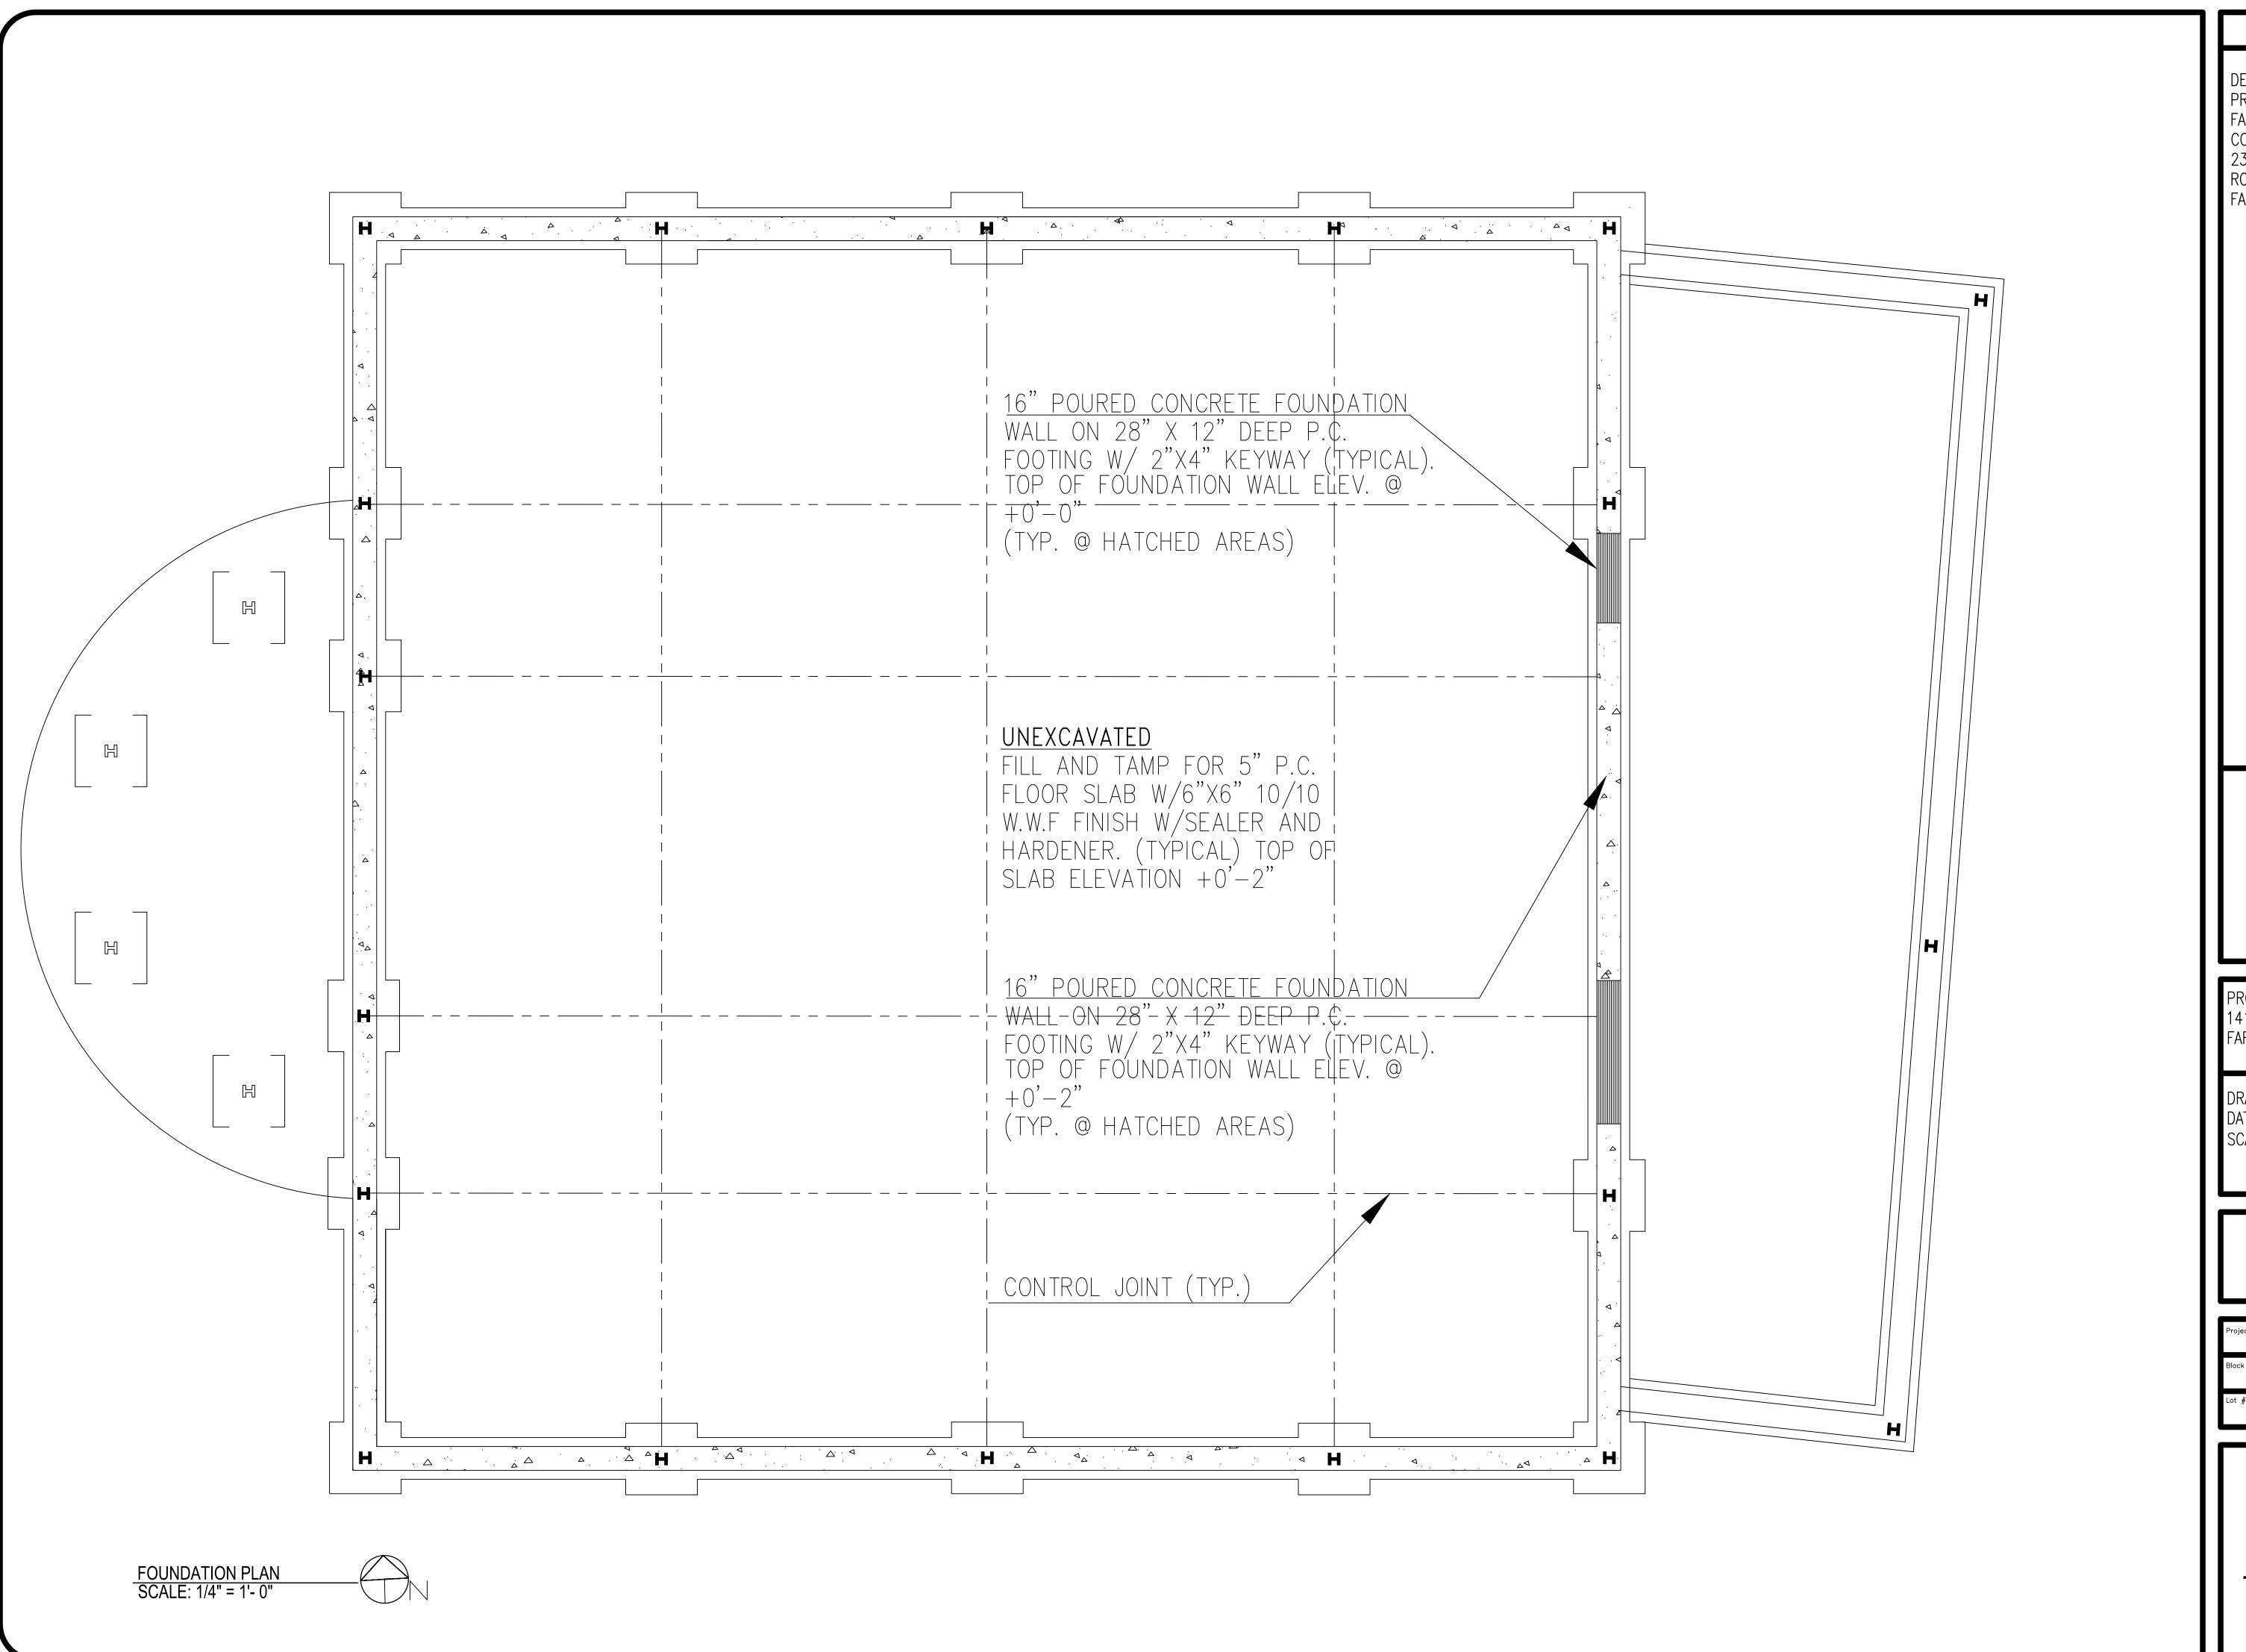

DESIGN 4
PROFESSOR ANDERSON
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ROAD
FARMINGDALE NY 11735

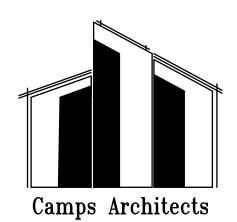


PROJECT ADDRESS: 141 DIVISION ST. FARMINGDALE NY, 11735

DRAWN BY: S.C DATE: 19MAY2025SCALE 1/4" = 1'- 0"

FOUNDATION PLAN


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l	Block	001
	Lot #:	17




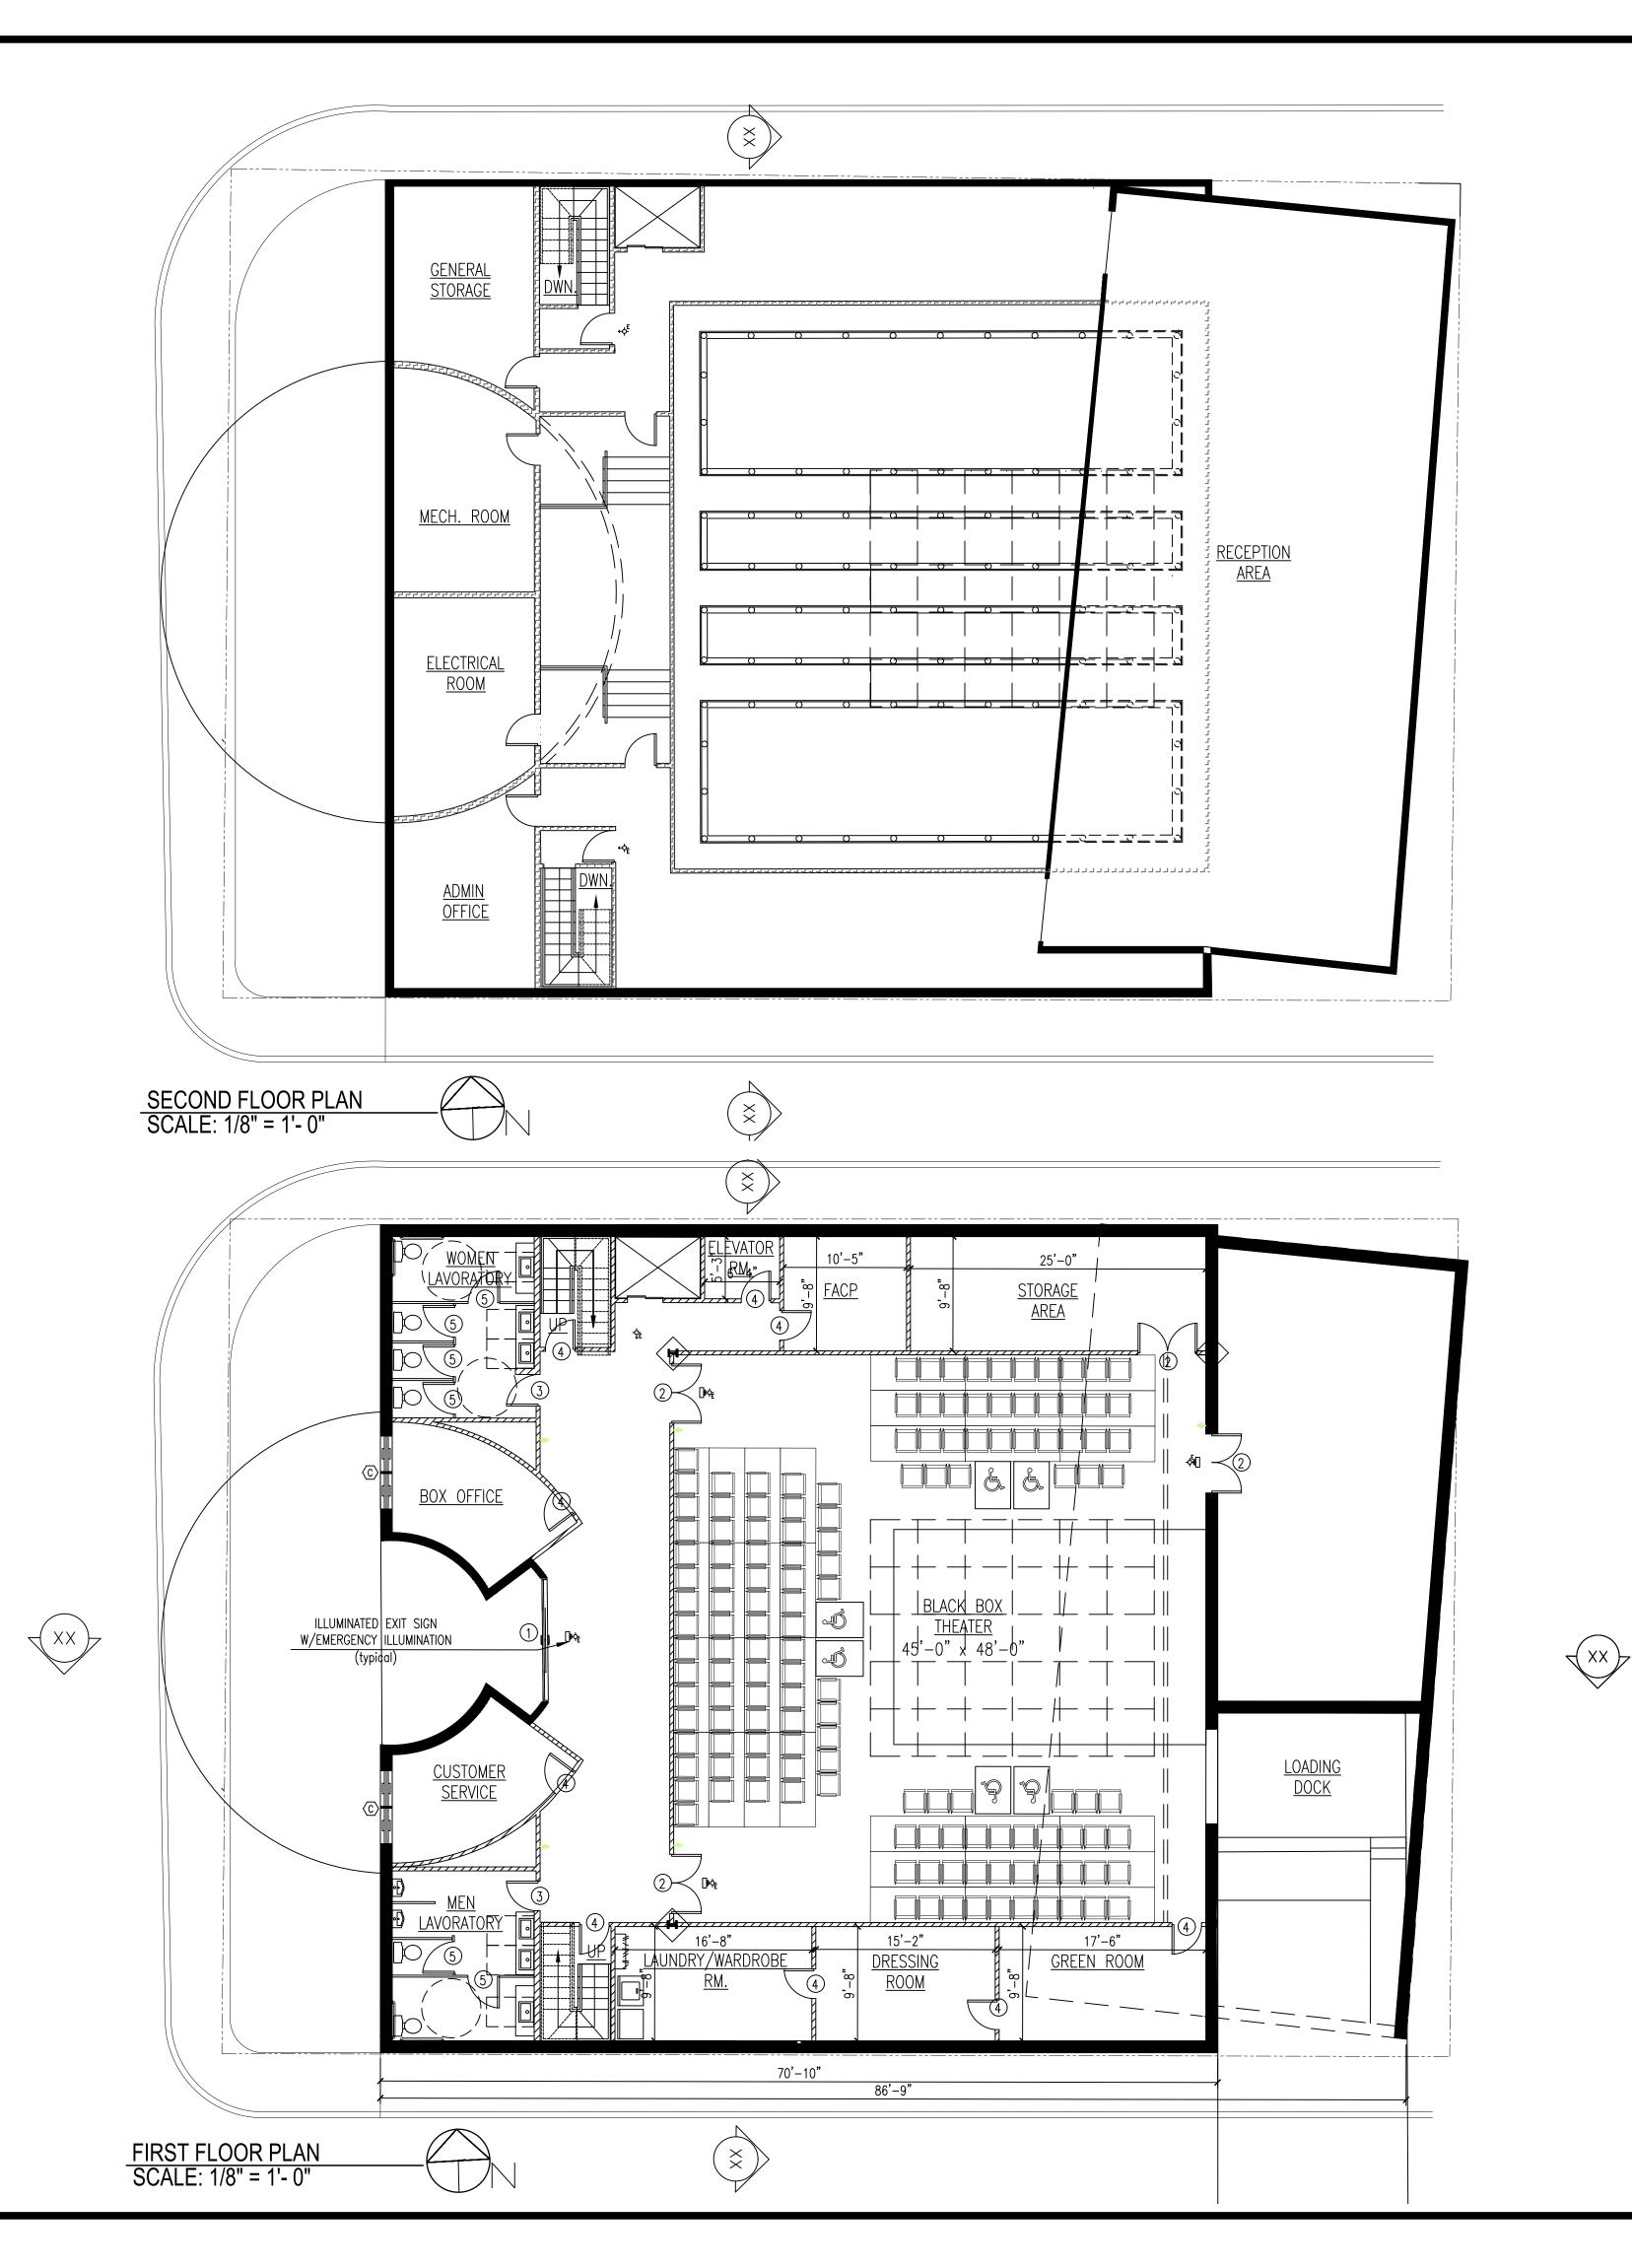


DOOR SCHEDULE	E NOTE: ALL GLASS DOORS AND GLASS SIDELITES TO BE ANDERSON STORMWATCH IMPACT RESISTANT UNITS					
MARK	SIZE (NOMINAL)		TYPE	COMMENTS		
1	5'-0" X 7'-8" X	1 3/4"	DURA-GLIDE ALL GLASS3000	with 1/2" Tempered with Po	olished Edges	
2	5'-0" X 7'-0" X	1 3/4"	STEEL PUSH/PULL DOOR	with Low Energy/Knowing Ad	t Swing Door Operator	
3	2'-8" X 7'-0" X	1 3/8"	PREHUNG HOLLOW METAL PUSH/PULL DOOR			
4	2'-6" X 6'-8" X	1 3/4"	STEEL PULL DOOR	with Low Energy/Knowing Ad	t Swing Door Operator	
5	2'-8" X 6'-8" X	1 3/8"	STEEL RAISED SWING			
WINDOW SCHEDULE NOTE: ALL WINDOWS TO BE ANDERSON STORM WATCH IMPACT RESISTANT UNITS						
MARK	SIZE (NOMINAL)	TYPE		COMMENTS		
(A)	4'-0" X 5'-0"	STOREFRONT LOW WINDOWS		U =.32		
⟨B⟩	4'-0" X 4'-0"	STOREFRONT HIGH WINDOWS		U =.32		
C	3'-0" X 3'-0"		BOX OFFICE WINDOW		U =.32	

DOOR SCHEDULE ELEVATIONS:

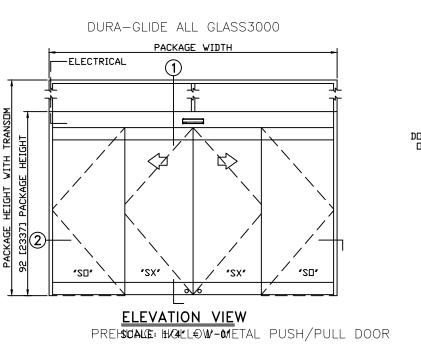


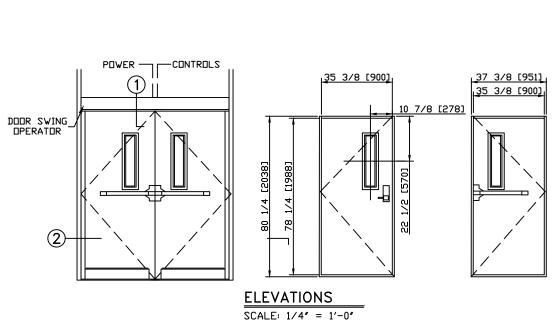



STEEL PUSH/PULL DOOR

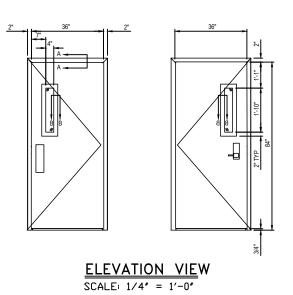

WINDOW SCHEDULE ELEVATIONS:

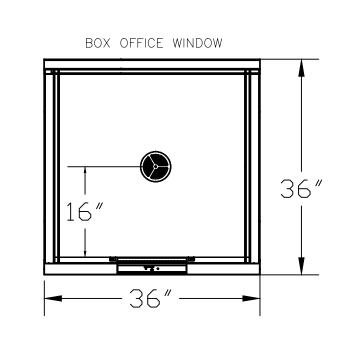

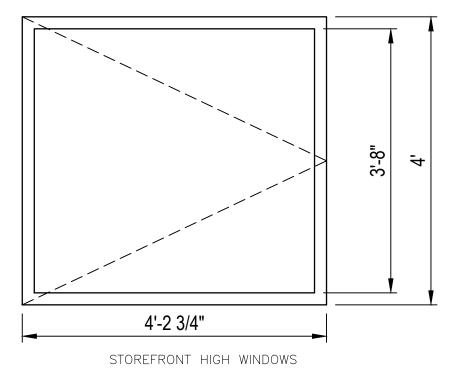

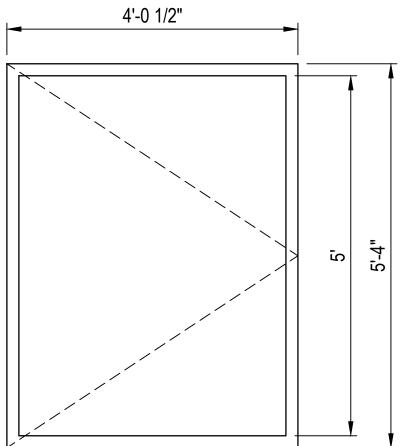

STOREFRONT LOW WINDOWS

ELEVATION VIEW SCALE: 3/4" = 1'-0"

General Notes

DESIGN 4
PROFESSOR ANDERSON
FARMINGDALE STATE
COLLEGE
2350 BROADHOLLOW
ROAD
FARMINGDALE NY
11735

X INDICATES DOOR (SEE DOOR SCHEDULE)

(X) INDICATES WINDOWS (SEE WINDOW SCHEDULE)




PROJECT ADDRESS: 141 DIVISION ST. FARMINGDALE NY, 11735

DRAWN BY: S.C DATE: 19MAY2025SCALE 1/4" = 1'-0"


> FIRST & SECOND FLOOR PLANS

Project Section	49	
Block	001	
Lot # :	17	

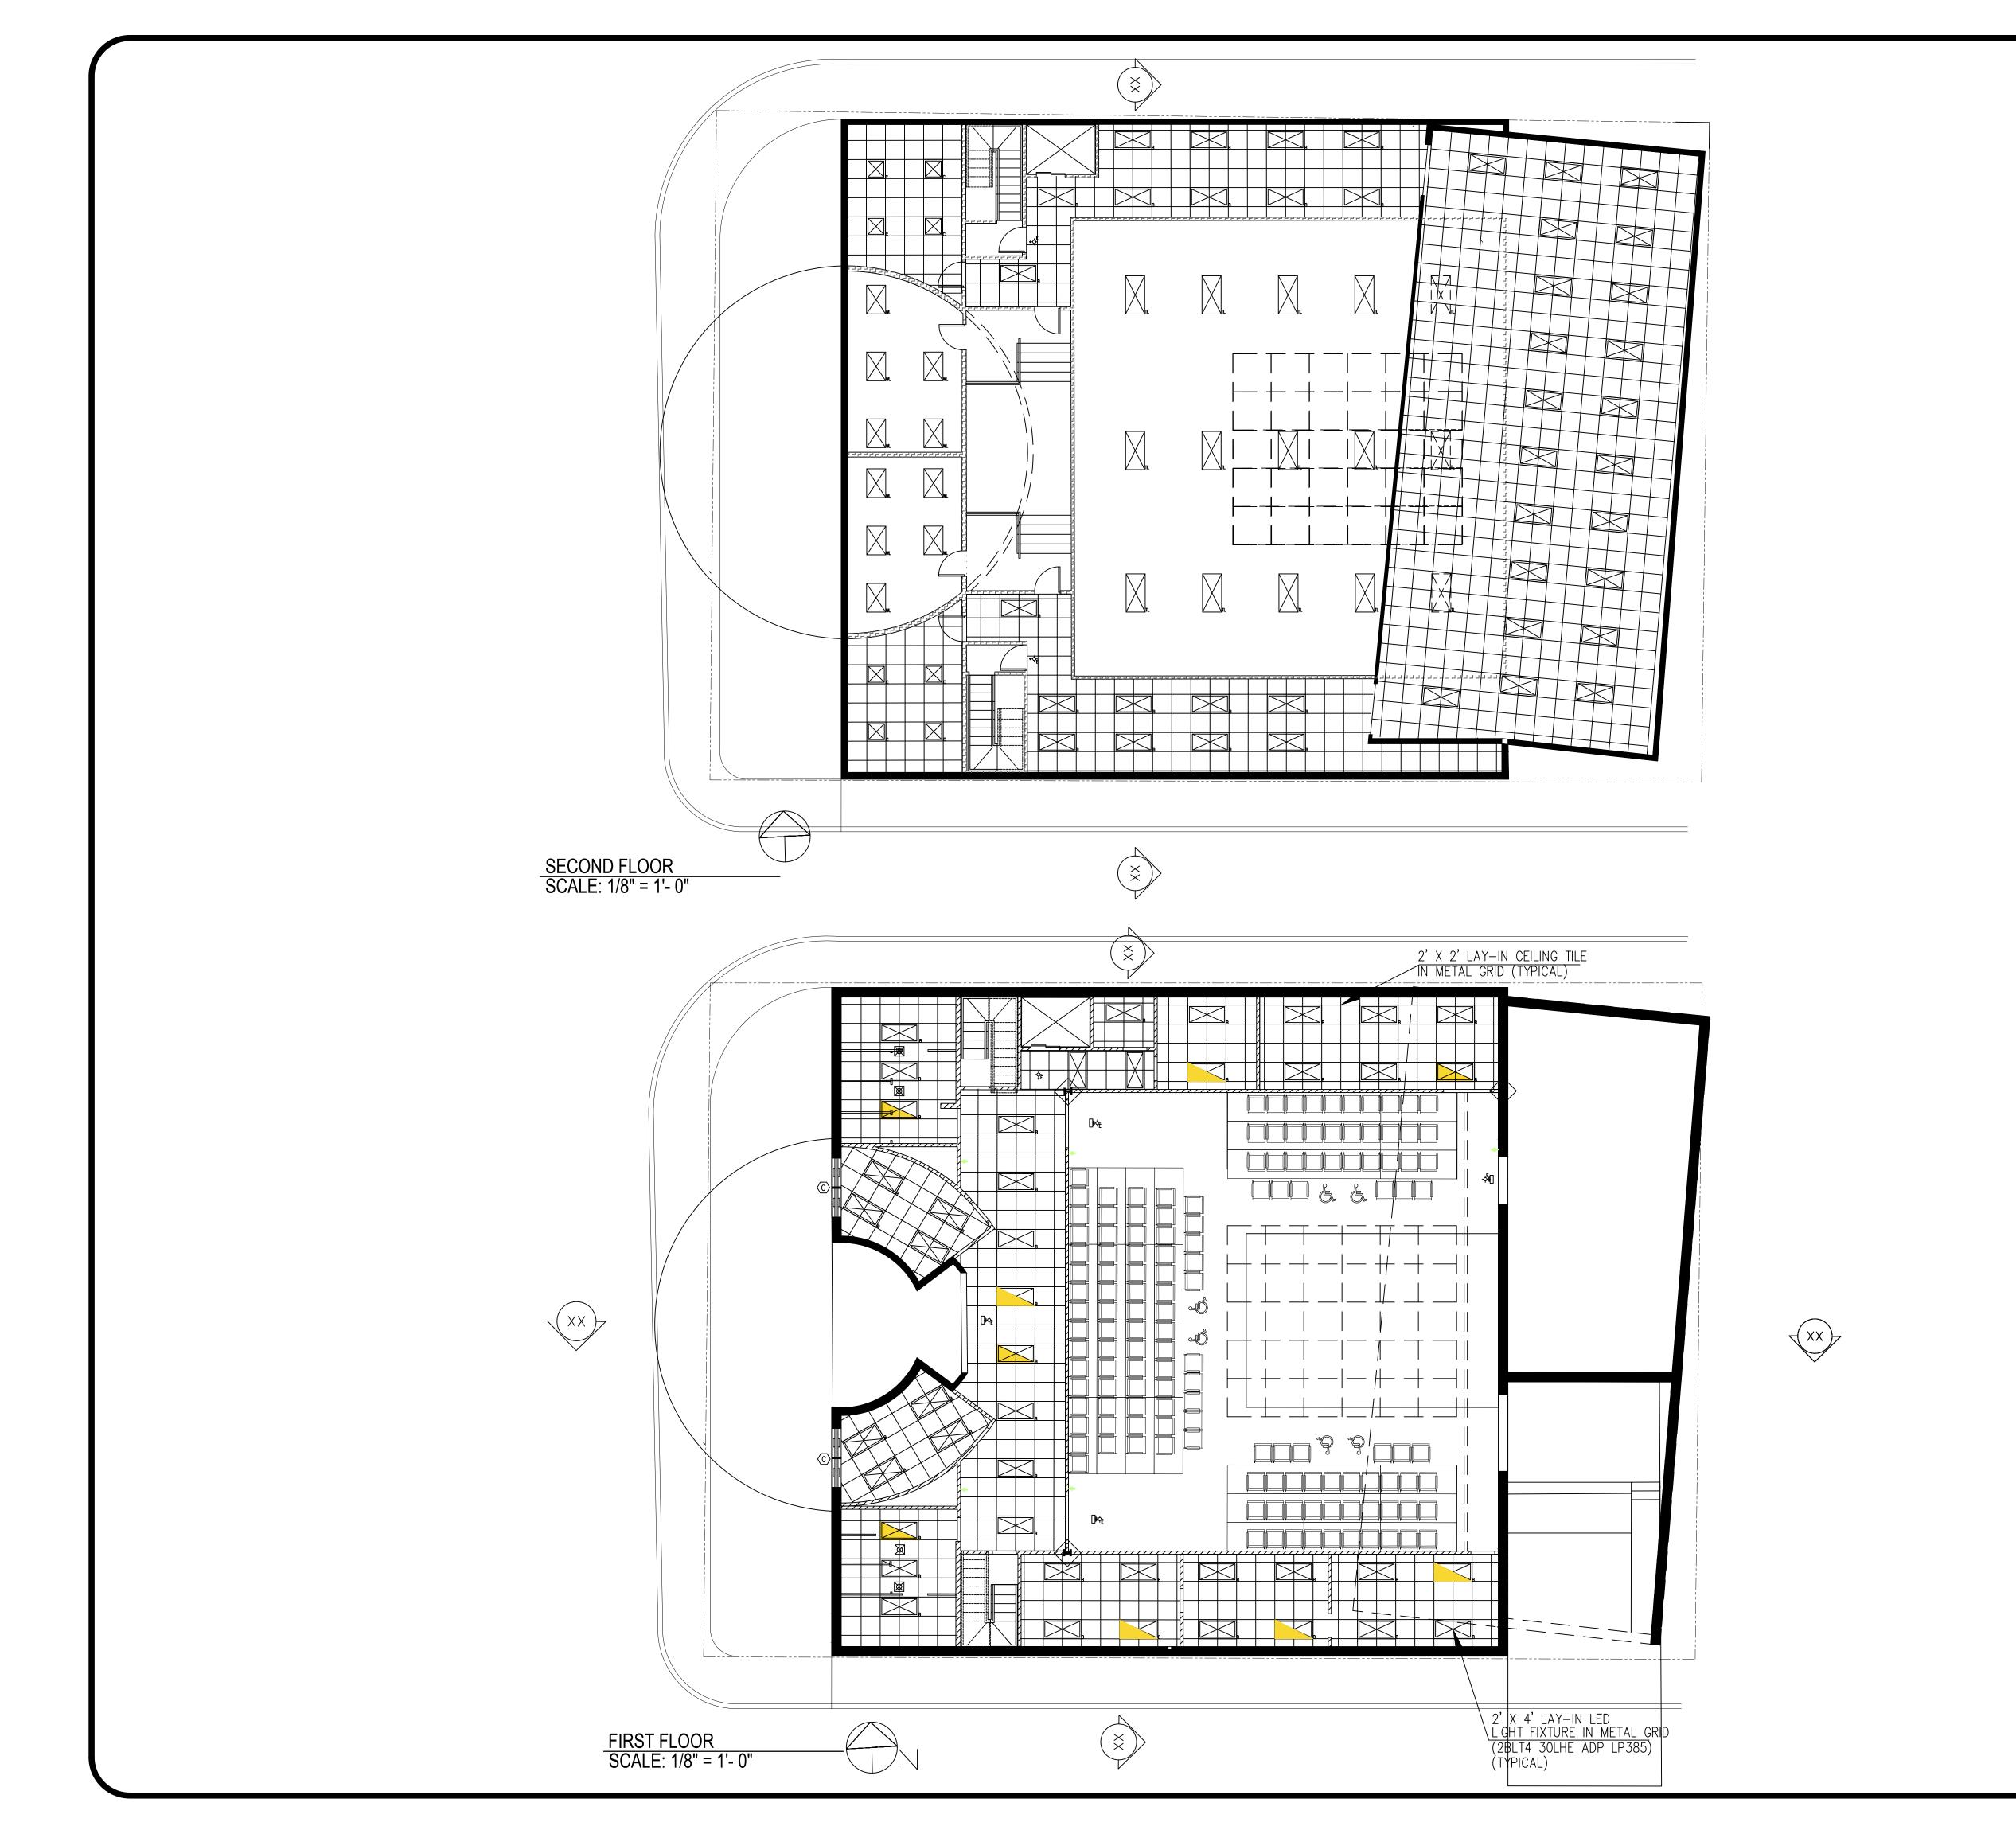

Conord Ubles

DESIGN 4
PROFESSOR
ANDERSON
FARMINGDALE STATE
COLLEGE
2350 BROADHOLLOW
ROAD
FARMINGDALE NY
11735

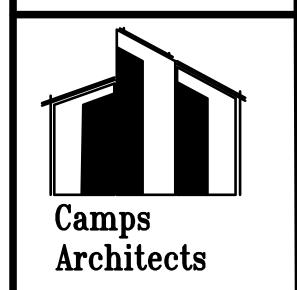


PROJECT ADDRESS: 141 DIVISION ST. FARMINGDALE NY, 11735

DRAWN BY: S.C DATE: 19MAY2025 SCALE 1/4" = 1'- 0"

REFLECTED CEILING PLAN


Project Section	49
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DESIGN 4
PROFESSOR ANDERSON
FARMINGDALE STATE
COLLEGE
2350 BROADHOLLOW

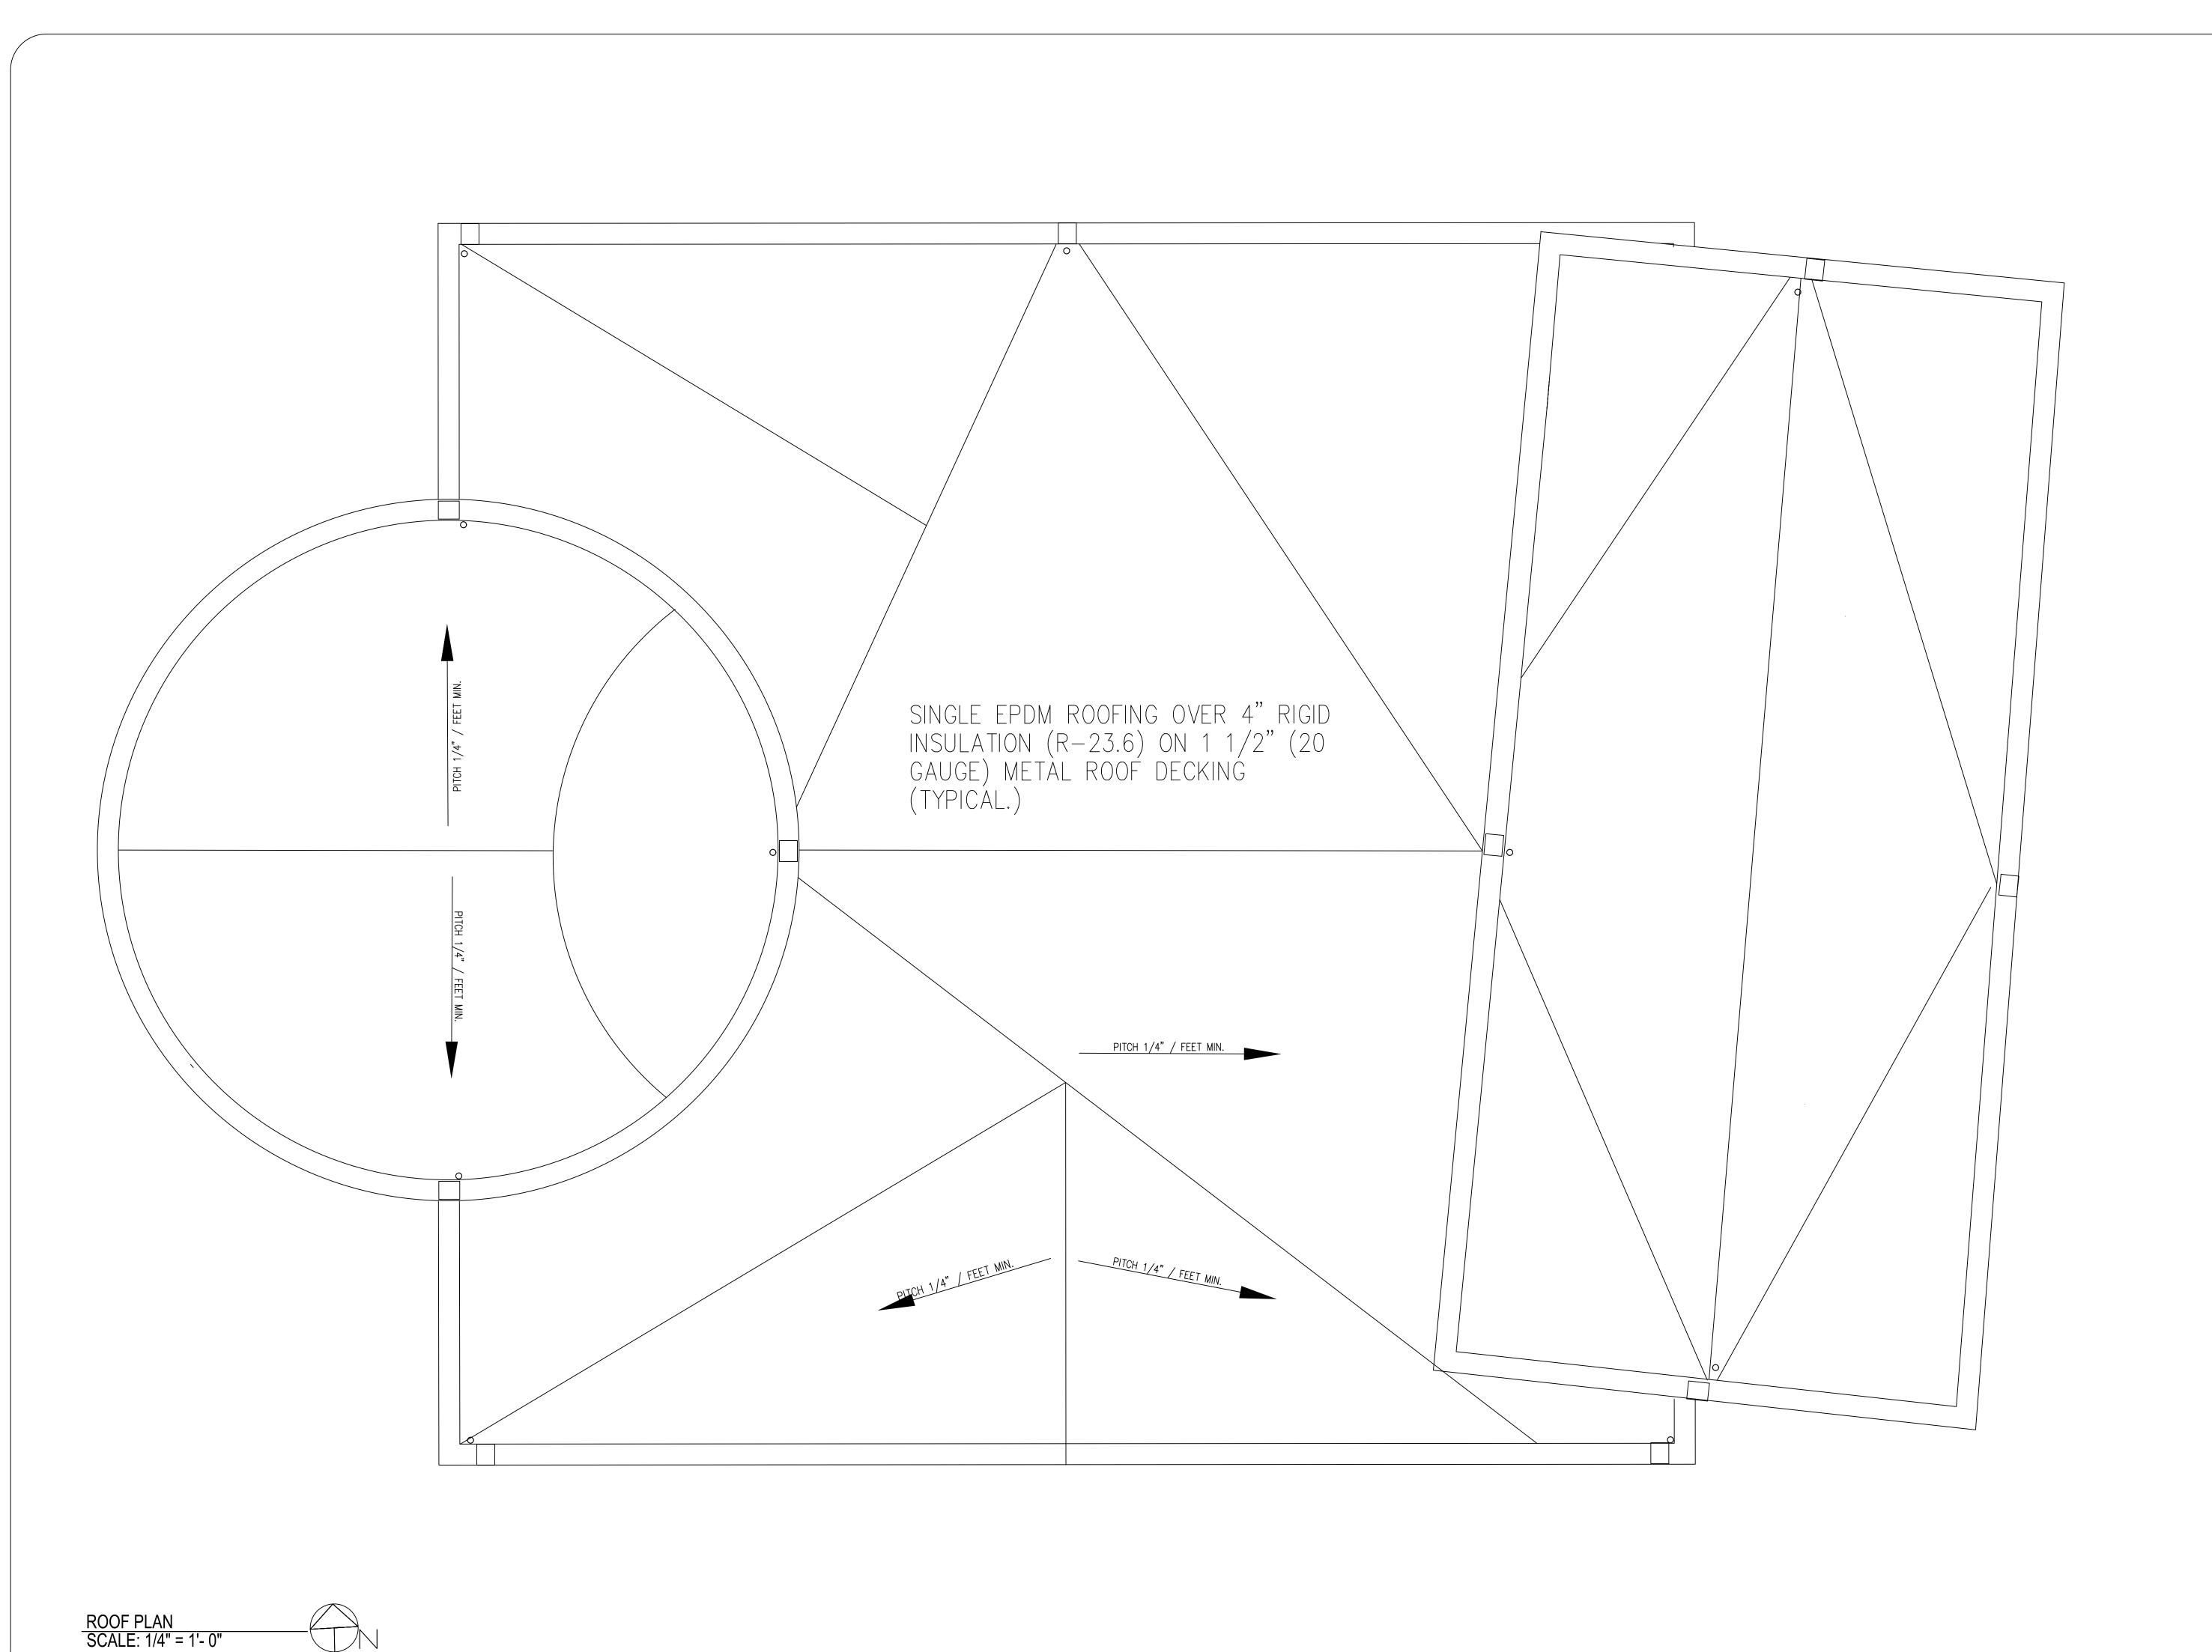ROAD

FARMINGDALE NY 11735




PROJECT ADDRESS: 141 DIVISION ST. FARMINGDALE NY, 11735

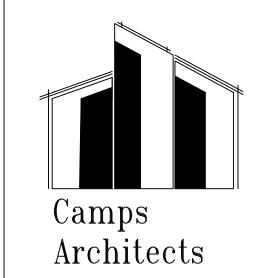DRAWN BY: S.C DATE: 19MAY2025 SCALE 1/4" = 1'- 0"

ROOF PLAN

	Project Section	49
	Block	001
	Lot # :	17

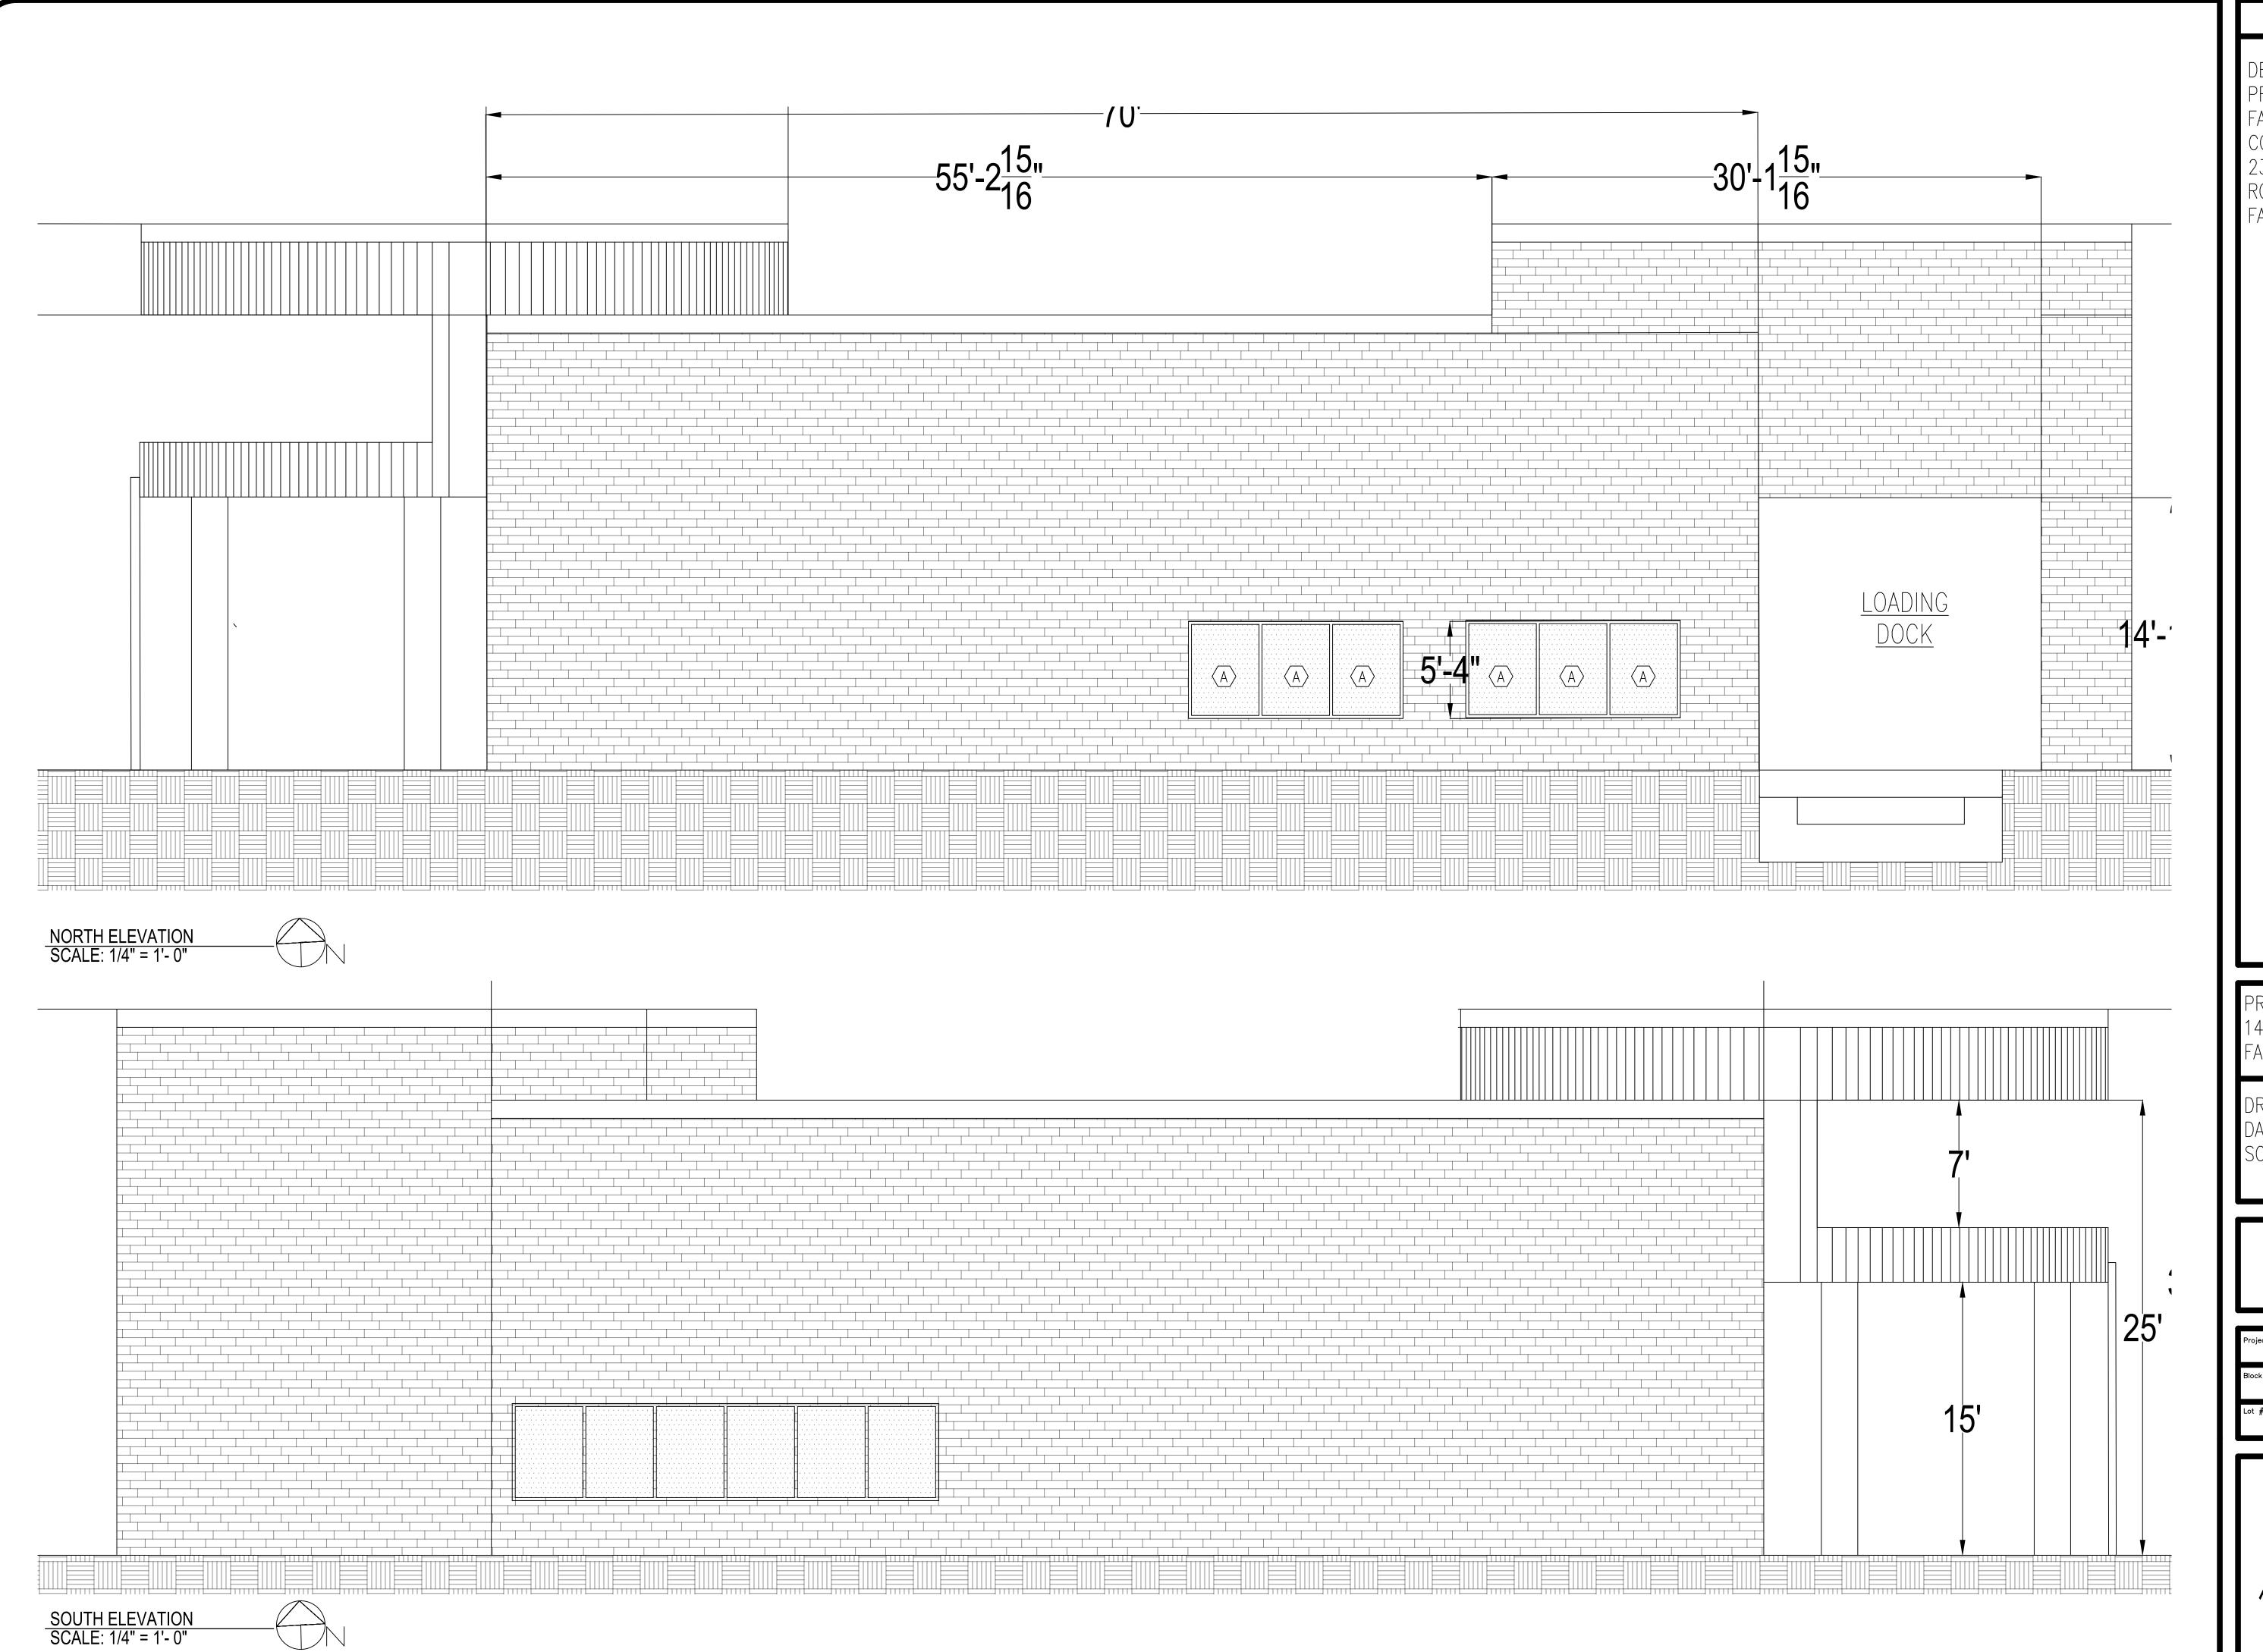

PROFESSOR ANDERSON FARMINGDALE STATE COLLEGE 2350 BROADHOLLOW


ROAD FARMINGDALE NY 11735

141 DIVISION ST. FARMINGDALE NY, 11735

Camps Architects

SCALE: AS NOTED

ELEVATIONS

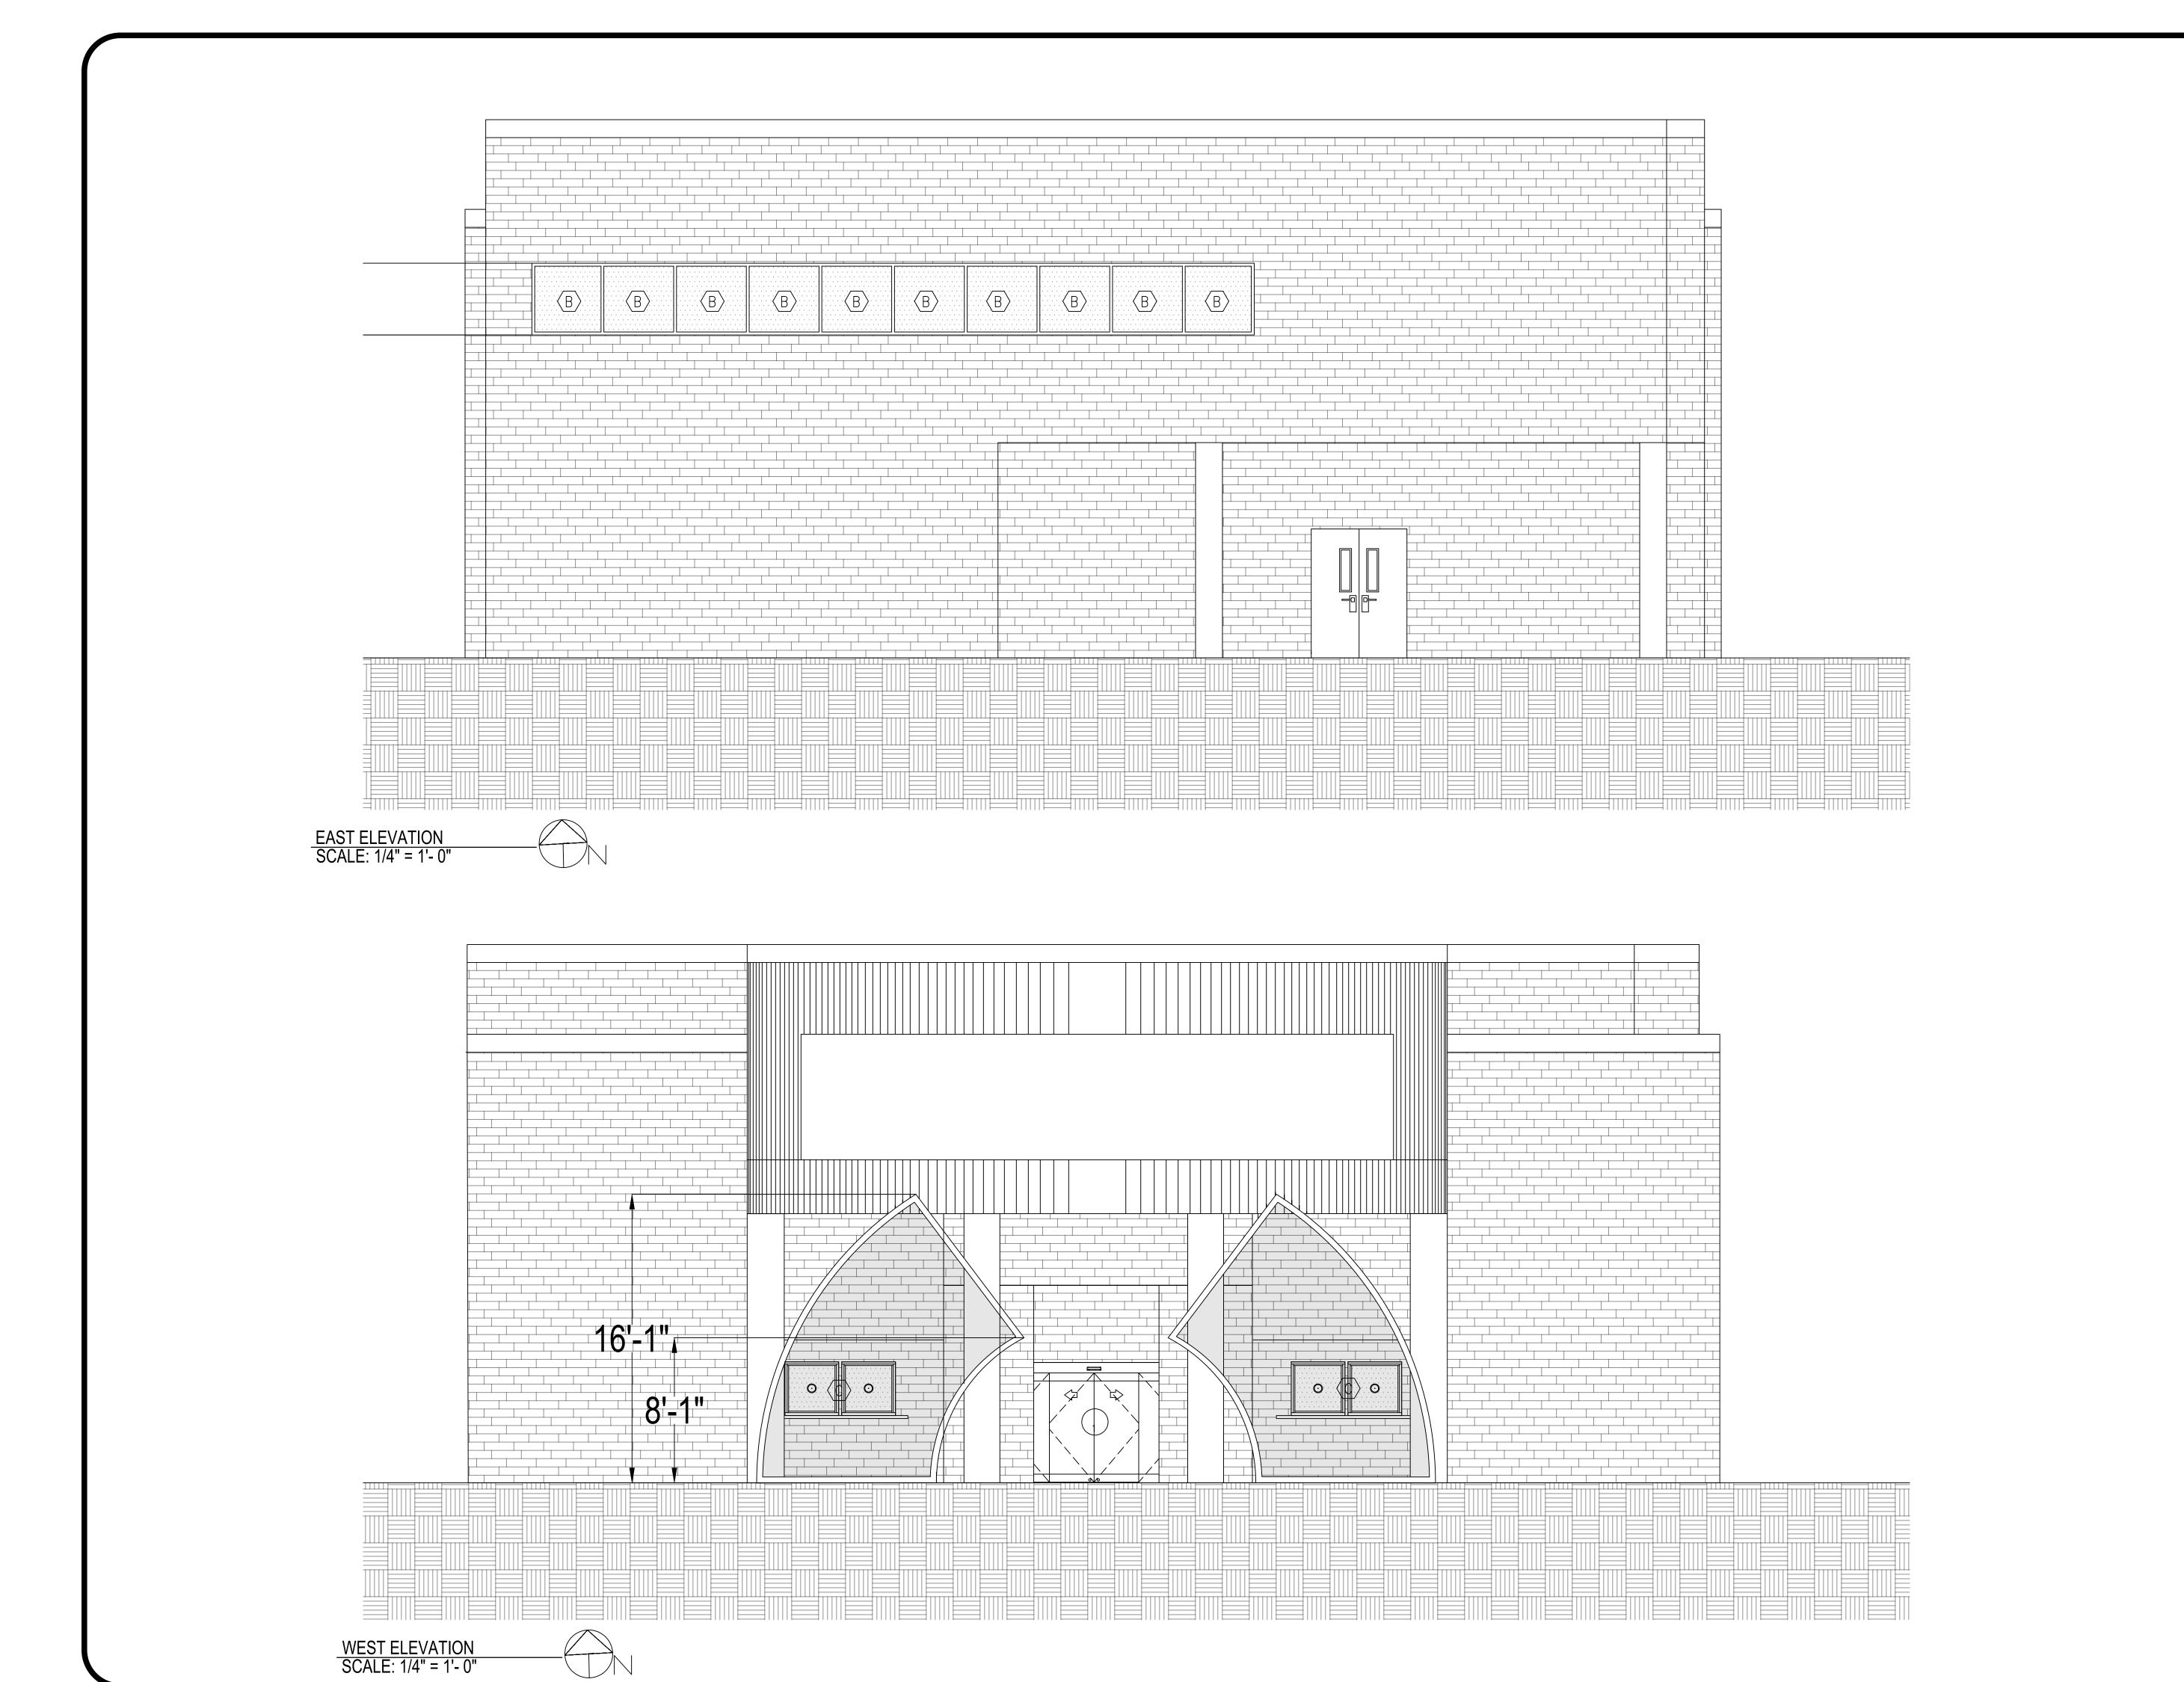

DESIGN 4 PROFESSOR ANDERSON

FARMINGDALE STATE COLLEGE

2350 BROADHOLLOW ROAD

FARMINGDALE NY 11735



PROJECT ADDRESS: 141 DIVISION ST. FARMINGDALE NY, 11735

DRAWN BY: S.C DATE: 19MAY2025 SCALE: AS NOTED


ELEVATIONS

Project Section

Block

1

Lot #:

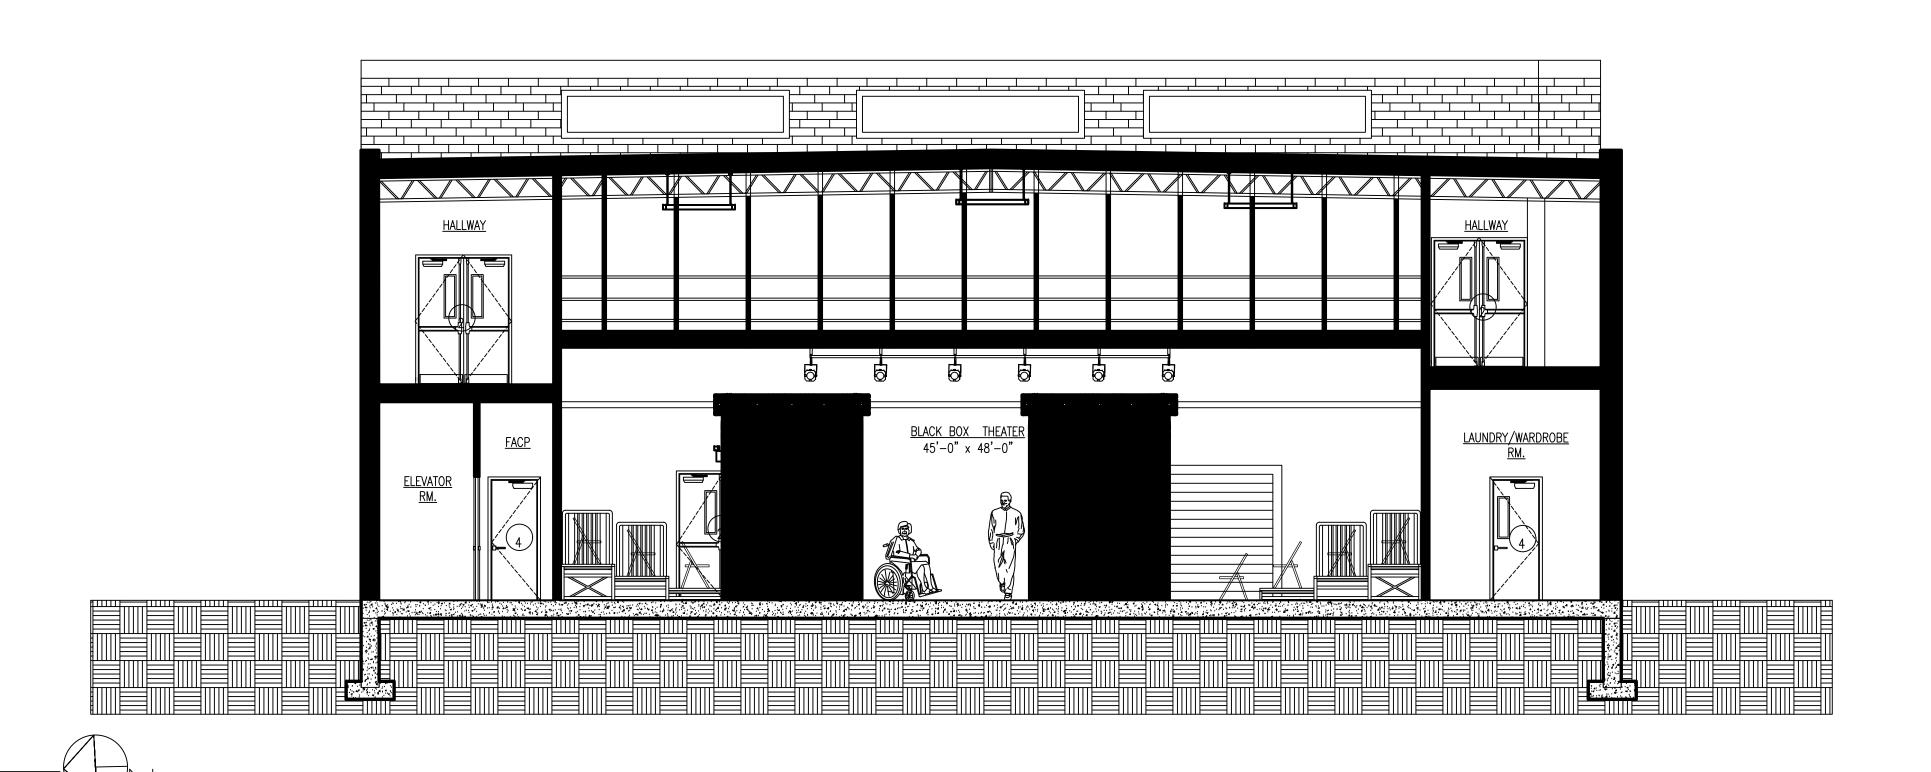


NATURES AND STATE OF THE PROPERTY OF THE PROPE

SOUTH SECTION
SCALE: 1/4" = 1'- 0"

WEST SECTION
SCALE: 1/4" = 1'- 0"

General Notes

PROFESSOR ANDERSO FARMINGDALE STATE COLLEGE 2350 BROADHOLLOW ROAD FARMINGDALE NY

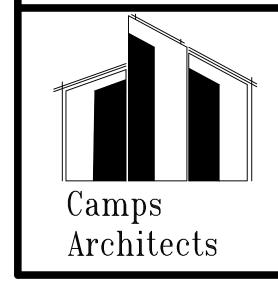


PROJECT ADDRESS: 141 DIVISION ST. FARMINGDALE NY, 11735

DRAWN BY: S.C DATE: 19MAY2025 SCALE 3/16" = 1'- 0"

SECTIONS


Project Section	49	
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DESIGN 4
PROFESSOR ANDERSON
FARMINGDALE STATE
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2350 BROADHOLLOW

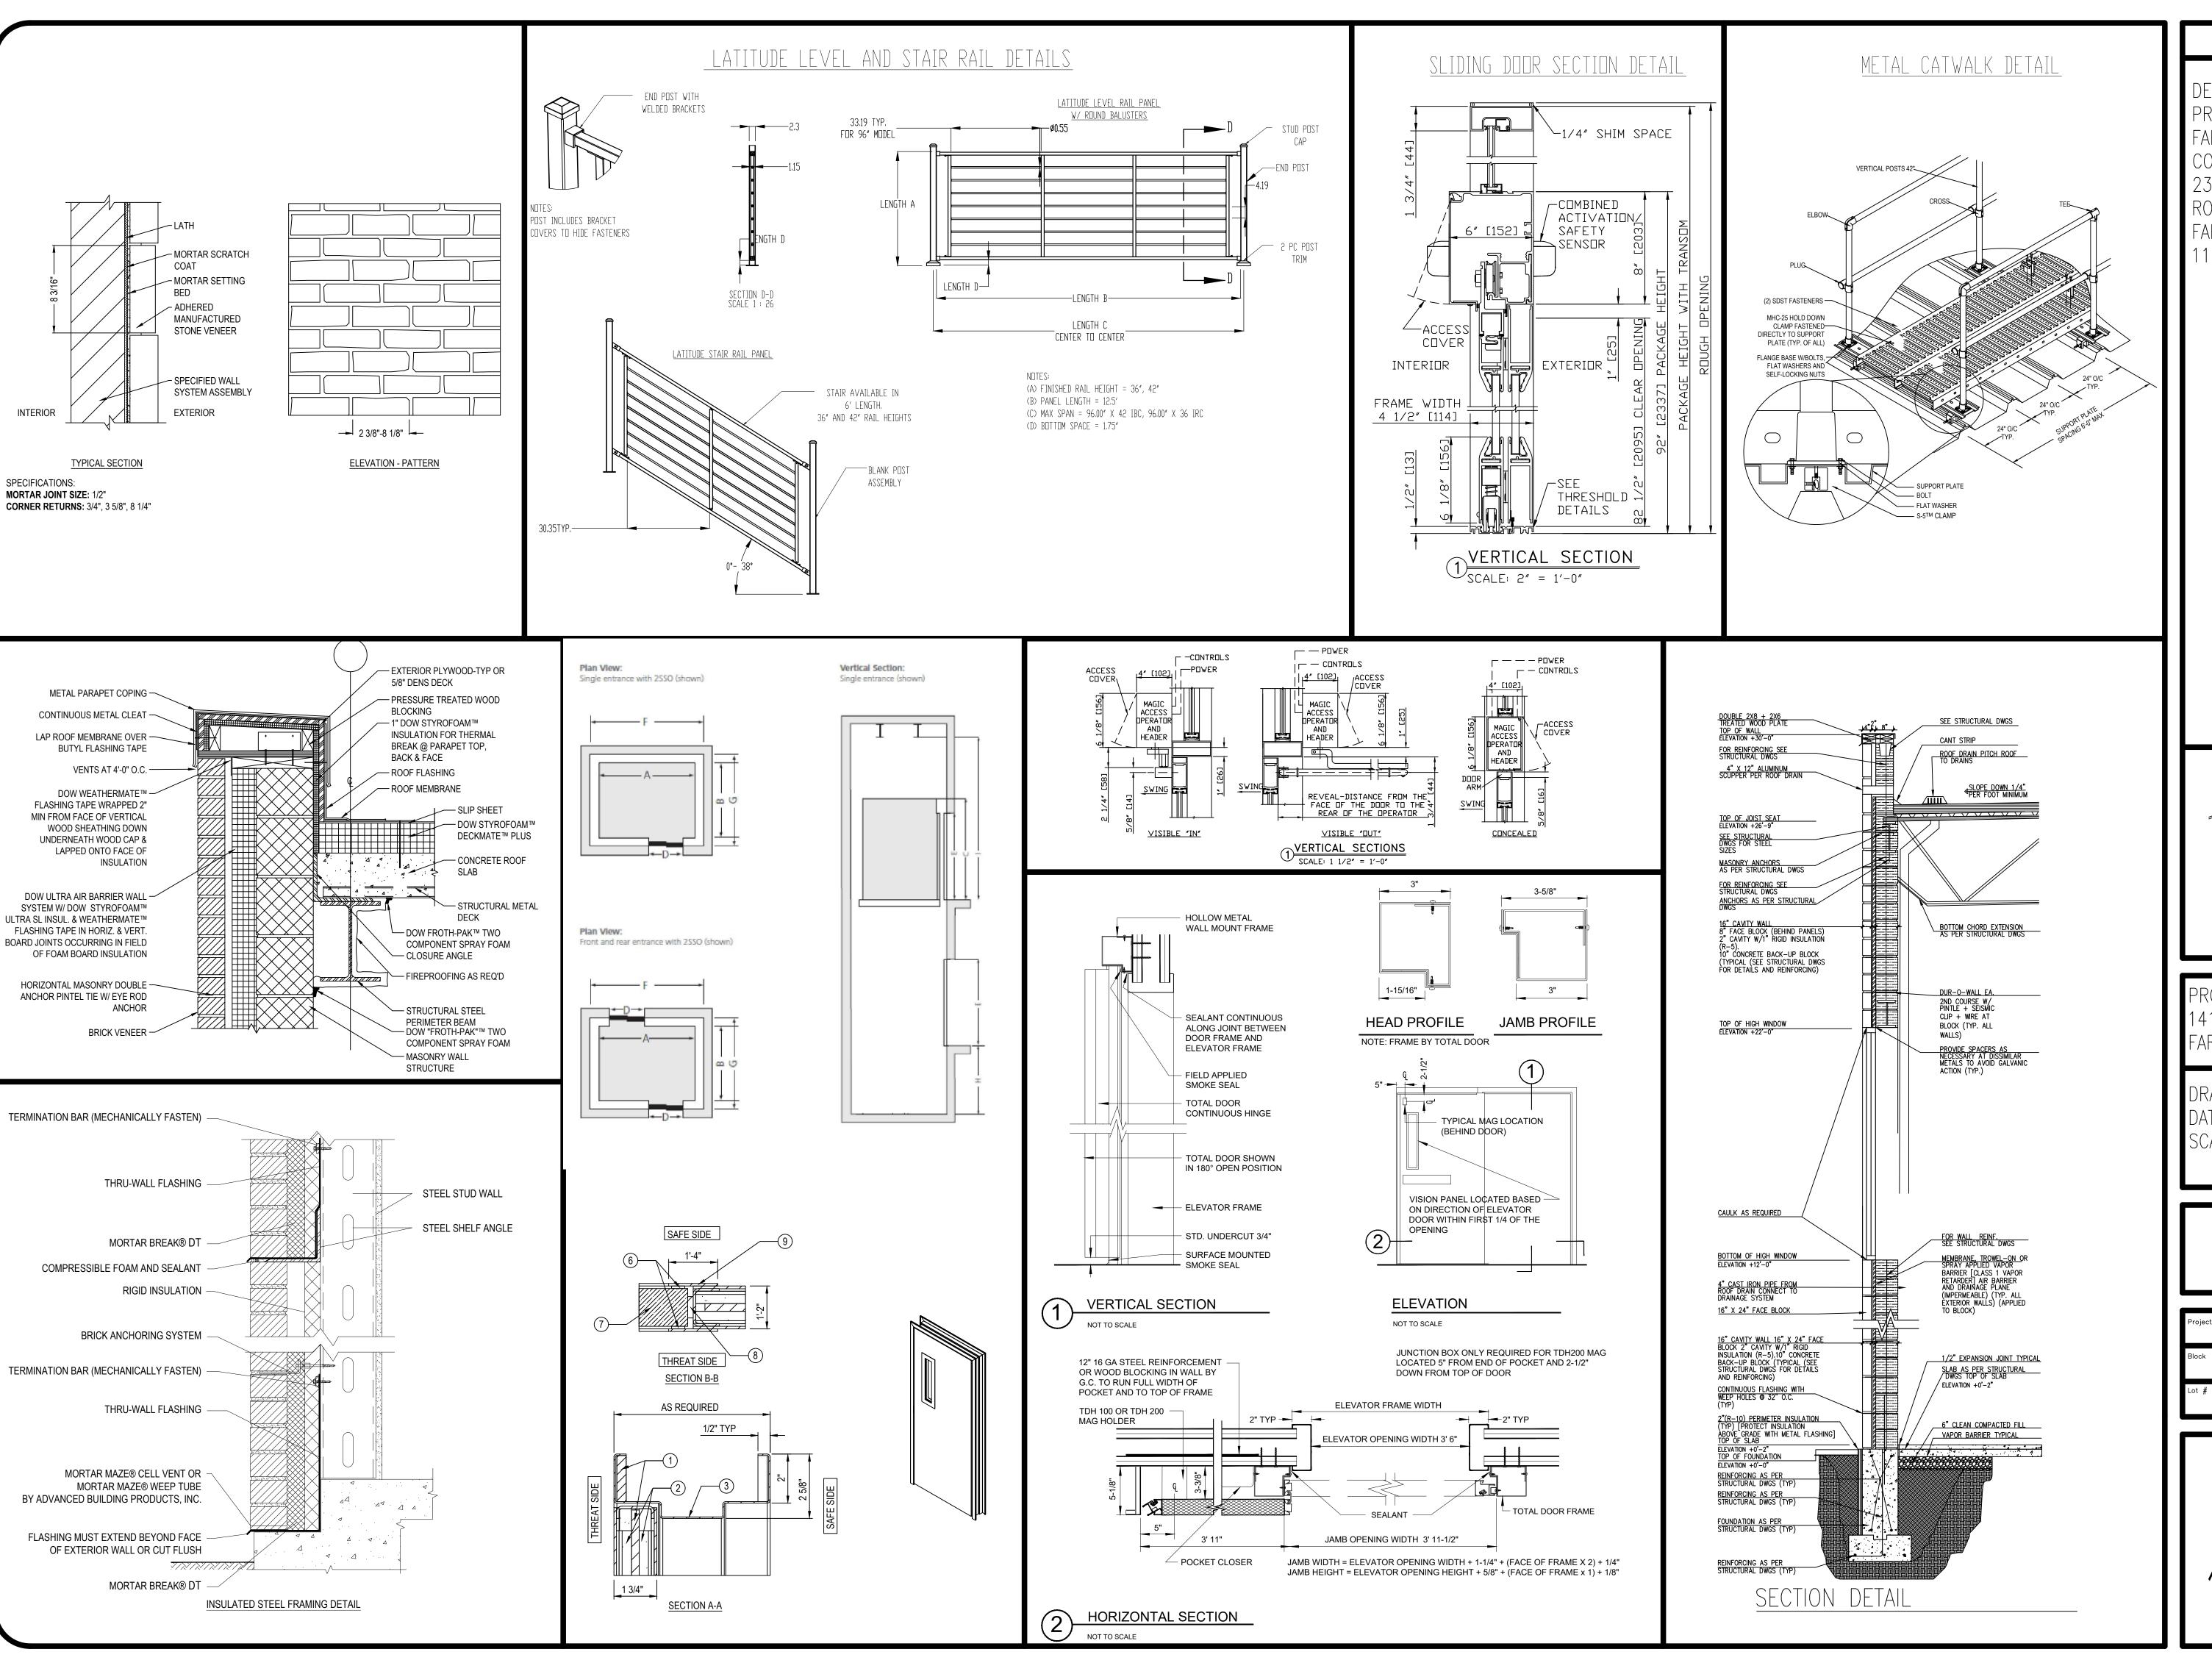ROAD

FARMINGDALE NY 11735



PROJECT ADDRESS: 141 DIVISION ST. FARMINGDALE NY, 1173:

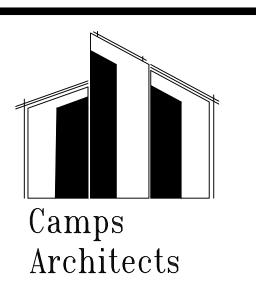DRAWN BY: S.C DATE: 19MAY2025 SCALE: NOT TO SCA

DETAILS

Project Section 49

Block 01

Lot #: 17